

Attachment 2 Applicant's Drawing Package



STATISTICS:

CIVIC ADDRESS: HOWE STREET & SPRICE STREET

LEGAL: LOTS 114 and 118, ALL OF DISTRICT LOT 757, GROUP 1. NEW WESTMINSTER DISTRICT PLAN 21376

CURRENT ZONING: RQ-1 PROPOSED ZONING: RT-2D

	future Lot 1	Lot 2	Lot 3	Lot 4	Lot 5	Lot 6	Lot 7	Lot 8	Lot 9	Lot 10
Site Area	3060 sf.	3168 sf.	3168 sf.	3168 sf.	3168 sf.	3060 sf.	3168 sf.	3168 sf.	3168 sf.	3168 sf.
	284.27 sm.	294.31 sm.	294.31 sm.	294.31 sm.	294.27 sm.	284.36 sm.	294.31 sm.	294.31 sm.	294.31 sm.	294.31 sm.
Site Frontage (min. 10% of perimeter)	25.83 ft. (9.1 %)	25.92 ft. (8.7 %)	25.83 ft. (9.0 %)	25.92 ft. (8.7 %)	25.92 ft. (8.7 %)	25.92 ft. (8.7 %)	25.92 ft. (8.7 %)			
	7.87 m. *	7.90 m. *	7.90 m. *	7.90 m. *	7.90 m. *	7.87 m. *	7.90 m. *	7.90 m. *	7.90 m. *	7.90 m. *
Unit Type	A	В	В	В	В	Α	В	В	В	В
Site Coverage - Principle Building (35% max. allowable)	1071 sf 35%	869 sf 27.43%	869 sf 27.43%	869 sf 27.43%	869 sf 27.43%	1071 sf 35%	869 sf 27.43%	869 sf 27.43%	869 sf 27.43%	869 sf 27.43%
	99.5 sm.	80.73 sm.	80.73 sm.	80.73 sm.	80.73 sm.	99.5 sm.	80.73 sm.	80.73 sm.	80.73 sm.	80.73 sm.
Site Coverage - Attached Accessory (10% max. allowable)	293.5 sf 9.6%	316.5 sf 10%	316.5 sf 10%	316.5 sf 10%	316.5 sf 10%	293.5 sf 9.6%	316.5 sf 10%	316.5 sf 10%	316.5 sf 10%	316.5 sf 10%
	27.27 sm.	29.4 sm.	29.4 sm.	29.4 sm.	29.4 sm.	27.27 sm.	29.4 sm.	29.4 sm.	29.4 sm.	29.4 sm.
Site Coverage - Detached Accessory (greater of 15% or 400 sf)	242 sf 7.9%	440 sf 13.9%	440 sf 13.9%	440 sf 13.9%	440 sf 13.9%	242 sf 7.9%	440 sf 13.9%	440 sf 13.9%	440 sf 13.9%	440 sf 13.9%
	22.5 sm.	40.87 sm.	40.87 sm.	40.87 sm.	40.87 sm.	22.5 sm.	40.87 sm.	40.87 sm.	40.87 sm.	40.87 sm.
Impervious Surfaces in % (total area)	1382 sf 45.2%	1464 sf 46.2%	1464 sf 46.2%	1464 sf 46.2%	1464 sf 46.2%	1382 sf 45.2%	1464 sf 46.2%	1464 sf 46.2%	1464 sf 46.2%	1464 sf 46.2%
	128.4 sm.	136.0 sm.	136.0 sm.	136.0 sm.	136.0 sm.	128.4 sm.	136.0 sm.	136.0 sm.	136.0 sm.	136.0 sm.
Average Grade / Crawl Space Height to U/S Structure	7.75 ft. / 3.75 ft.	7.42 ft. / 4.08 ft.	7.16 ft. / 4.33 ft.	6.92 ft. / 4.58 ft.	6.75 ft. / 4.75 ft.	6.0 ft. / 4.92 ft.	5.83 ft. / 4.92 ft.	5.67 ft. / 4.92 ft.	5.58 ft. / 4.92 ft.	5.42 ft. / 4.92 ft.
	2.36 m. / 1.24 m.	2.26 m. / 1.24 m.	2.18 m. / 1.32 m.	2.11 m. / 1.40 m.	2.06 m. / 1.44 m.	1.82 m. / 1.50 m.	1.78 m. / 1.50 m.	. 1.72 m. / 1.50 m.	1.70 m. / 1.50 m.	1.65 m. / 1.50 m.
Detached Accessory										
- Min. Distance From Lane - 22.0 ft 19.67 ft. (Lane) = 2.33 ft.	2.5 ft. (0.76 m.)	2.5 ft. (0.76 m.)	2.5 ft. (0.76 m.)	2.5 ft. (0.76 m.)	2.5 ft. (0.76 m.)	2.5 ft. (0.76 m.)				

* Variance Permit required

** Mid-point of roof is calculated between Roof Peak and average of the underside of Eaves

19.83 ft.

Type A

UNIT BREAKDOWN :	Type A	Type B	SETBACKS:	Type A	Type B
Main Floor Area :	1065 sf. (98.9 sm.)	855 sf. (79.4 sm.)	Min. Front Yard - 10'-0"	17.58 ft. (5.36 m.)	16.75 ft. (5.10 m.)
Upper Floor Area :	820 sf. (76.2 sm.)	836 sf. (77.7 sm.)	Min. Rear Yard - 20% (24.44 ft.)	36.38 ft. (11.09 m.)	58.13 ft. (17.72 m.)
Total Floor Area :	1885 sf. (175.1 sm.)	1691 sf. (157.0 sm.)	Min. Side Yard - 7.0 ft. total	7.0 ft. (2.13 m.)	7.08 ft. (2.16 m.)

E. info@rwa.ca

STUDIO BREAKDOWN - TYP	PEB:		Type A	Type B
Main Floor Garage Area :	440 sf. (40.9 sm.)	Detached Accessory Building to	Proposed	Proposed
Upper Floor Studio Area :	440 sf. (40.9 sm.)	Principal Building - Min. 10.0 ft.	12.88 ft. (3.92 m.)	33.63 ft. (10.25 m.)

mid-point of sloped roof	fs **	(6.04 m.)	(6.04 m.)
F-STREET PARKING:	Min	. Required	Proposed
Туре А		1	1
Type B		1	2

BUILDING HEIGHT:

Max. 25.0 ft. allowable from

Geodetic Elev. - 11.58 ft. to

	Max. 15.0 ft. allowable for flat roofs	10.0 ft. (3.05 m.)
	Type B - Garage / Stud	lio
	Max. 15.0 ft. allowable to mid-point of sloped	16.75 ft. * (5.18 m.)
	roofs **	,

DRAWING LIST: Architocturo:

Archite	Clure.
DP0.01	Cover /
DD1 01	Overell

DP0.01	Cover / Stats
DP1.01	Overall Site Plan w/ No Build
	Covenant on Lot 1
DP1.02	Floor & Roof Plans - Type A
DP1.03	Building Elevations - Type A
DP1.04	Floor & Roof Plans - Type B
DP1.05	Building Elevations - Type B
DP1.06	Building Sections - Type A, B
DP1.07	Studio/Garage - w/ Height Variance
DP1.08	Material and Colour Combinations
DP1.09	Overall Site Plan - Ultimate Build Ou
DP1.10	Context Street Elevations
DP1.11	Illustrations / 3D Views
DP1.12	Illustrations / 3D Views
DP1.13	Illustrations / 3D Views

|--|

Type A & B Houses Roof Peak = 34'-0" Ave. of Eaves = 28'-11" Mid-point = 31'-5"

Type B - Garage / Studio Roof Peak = 27'-2" Ave. of Eaves = 19'-4" Mid-point = 23'-3"Height = 19.83' from G.E. 11.58' Height = 16.75' from finish floor

T. 604.736.8959

Canada V5T 3J7

Gilhurst Developments 9708 Gilhurst Crescent Richmond, BC V7A 1P2

OF


Sprice Street Flexible Family Housing


114 & 118 Sprice Street Queensborough, NW

Type B Type A - Garage

Cover Page Statistics / Drawing List

SCALE: DRAWN BY: ---

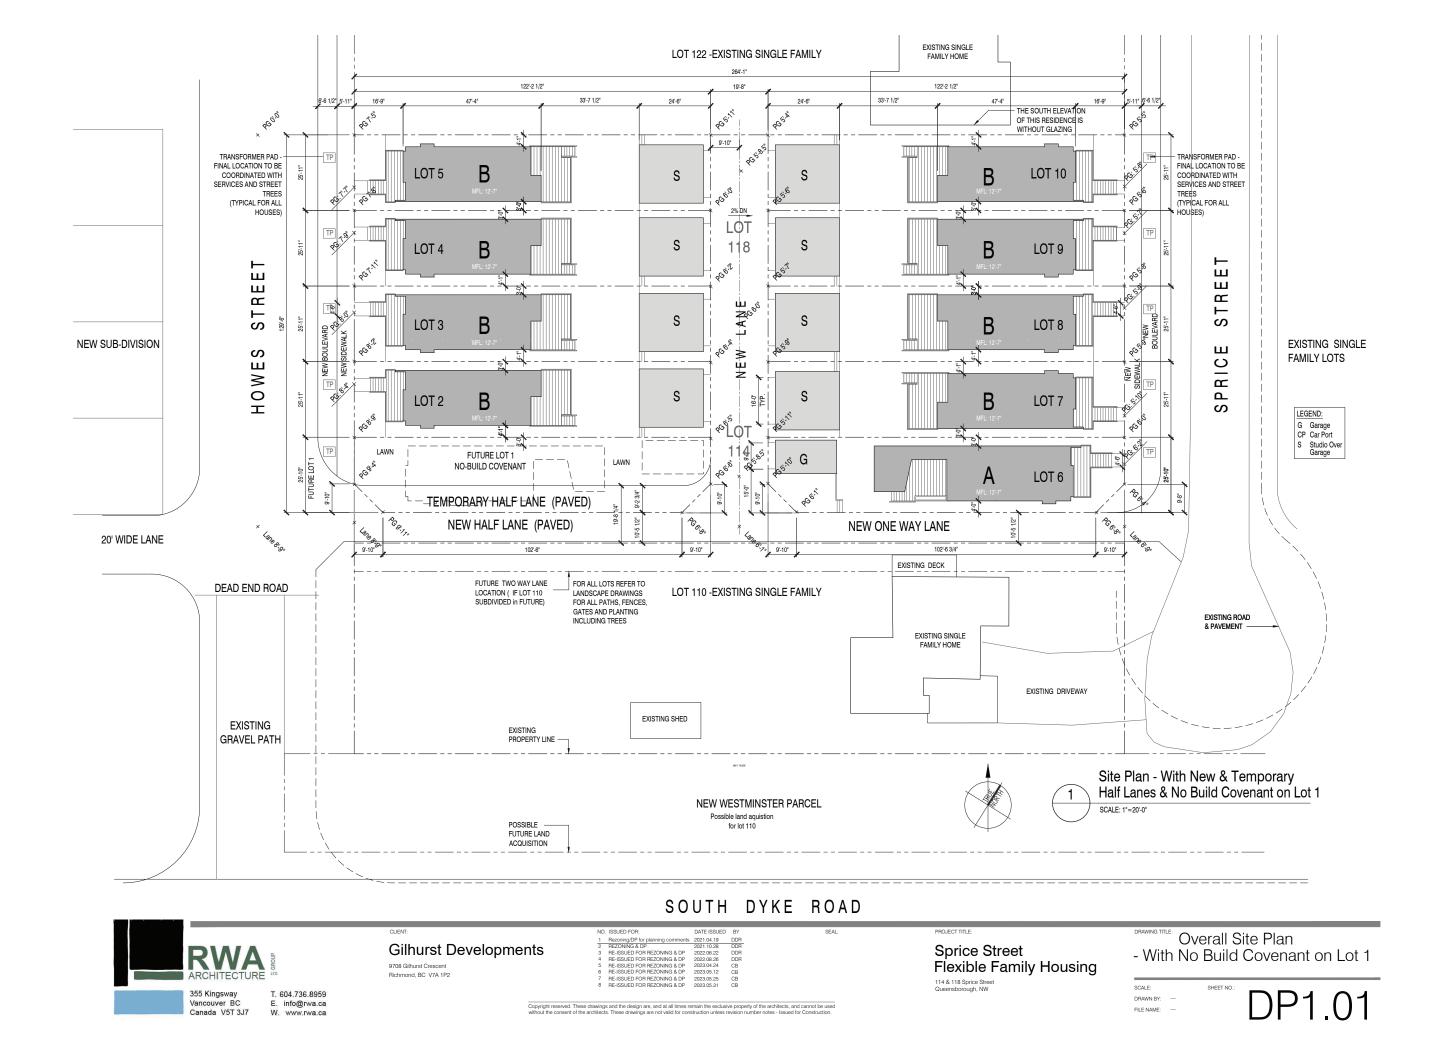

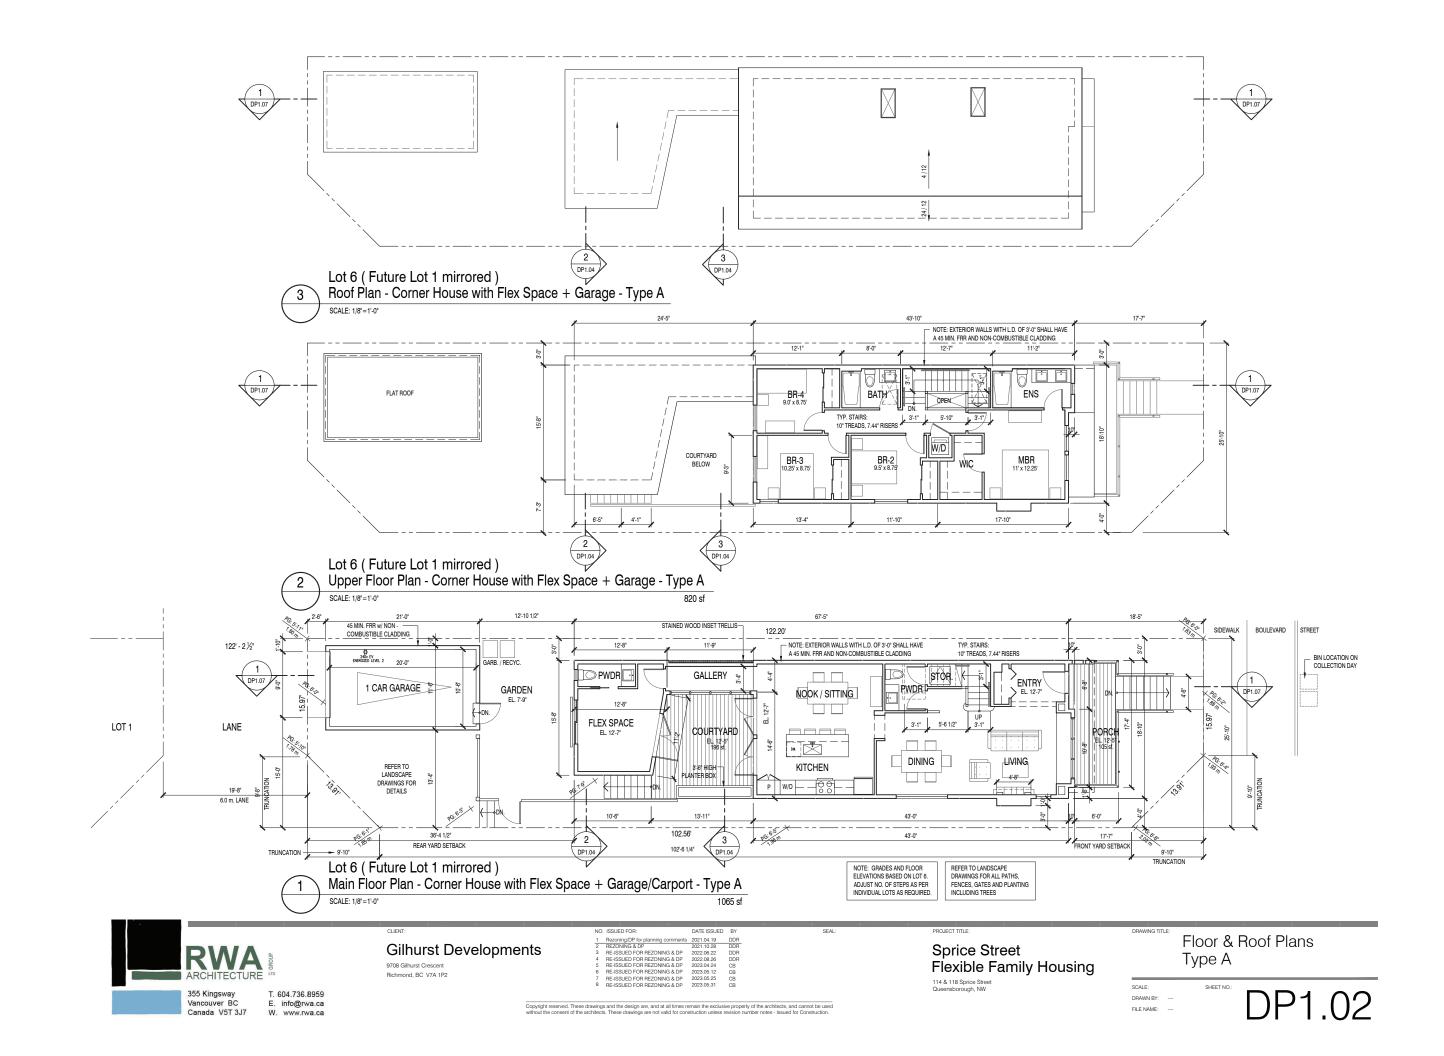





Canada V5T 3J7

W. www.rwa.ca

Gilhurst Developments

9708 Gilhurst Crescent Richmond, BC V7A 1P2

Sprice Street Flexible Family Housing

114 & 118 Sprice Street Queensborough, NW


Exterior Elevations Type A


SCALE:

DRAWN BY: ---

FILE NAME: ----

Corner House + Flex Space and Garage/Carport

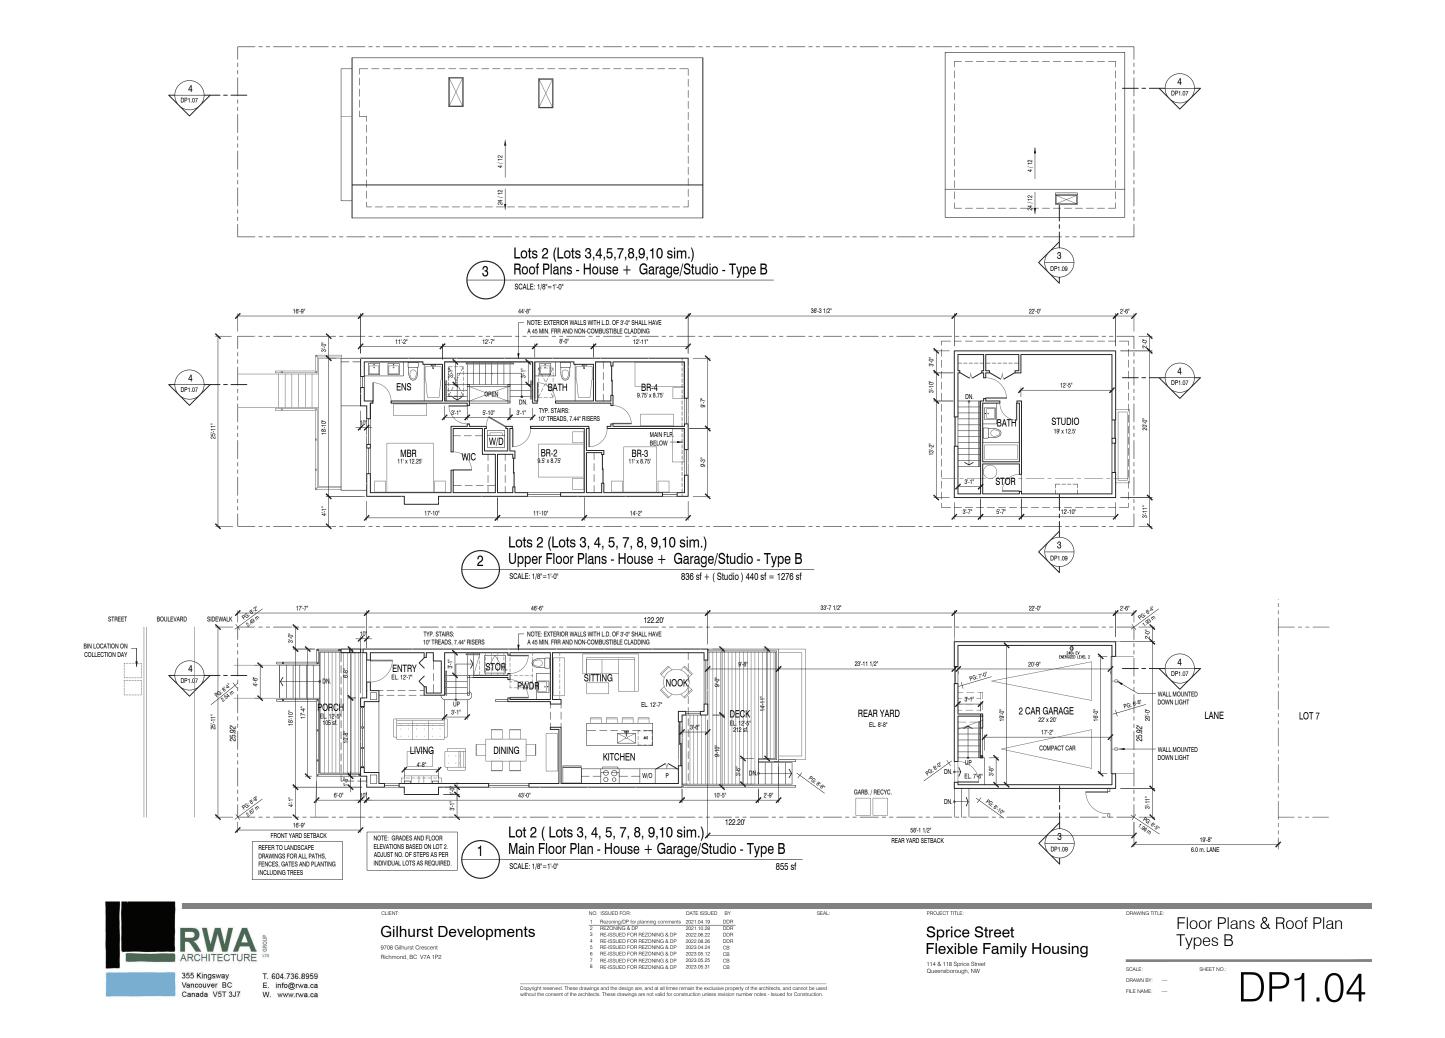

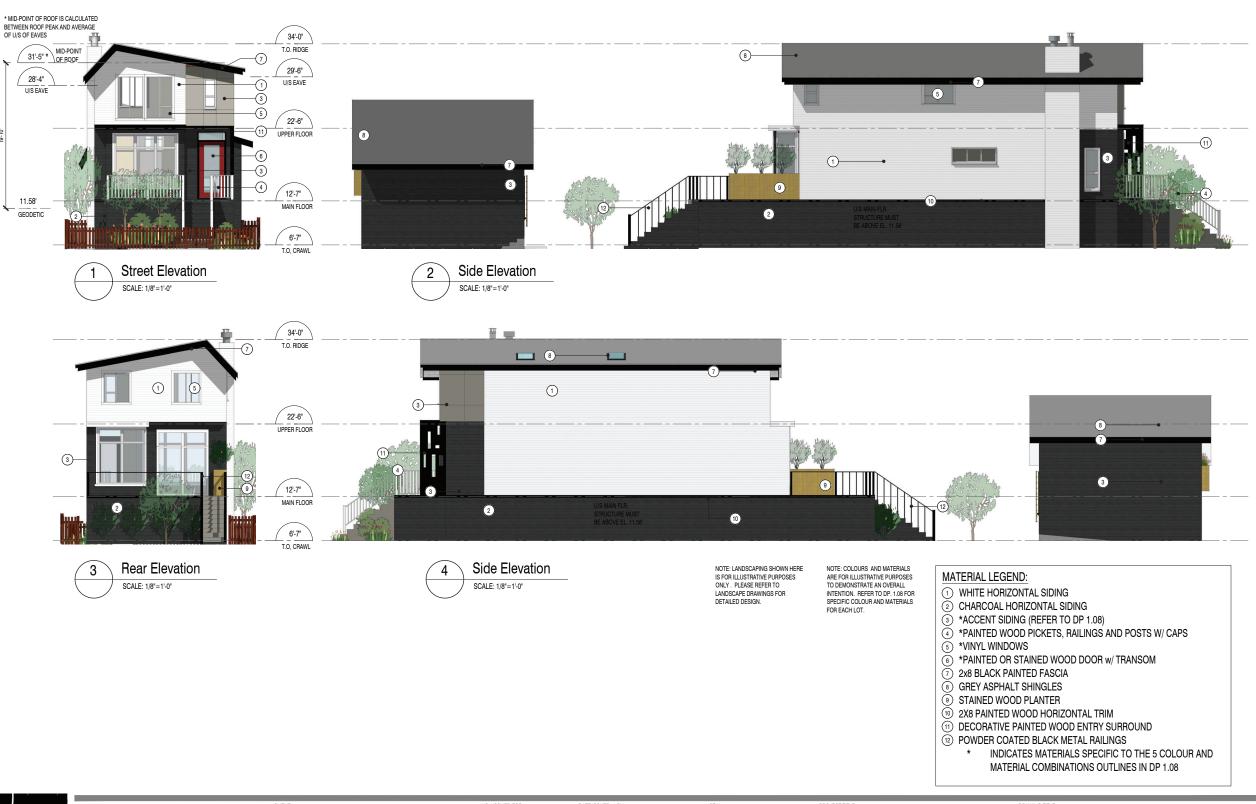



Canada V5T 3J7

W. www.rwa.ca

Gilhurst Developments 9708 Gilhurst Crescent Richmond, BC V7A 1P2

Sprice Street Flexible Family Housing

114 & 118 Sprice Street Queensborough, NW


SCALE:


DRAWN BY: ---

FILE NAME: ----


Exterior Elevations Type B House + Studio/Garage

DP1.05

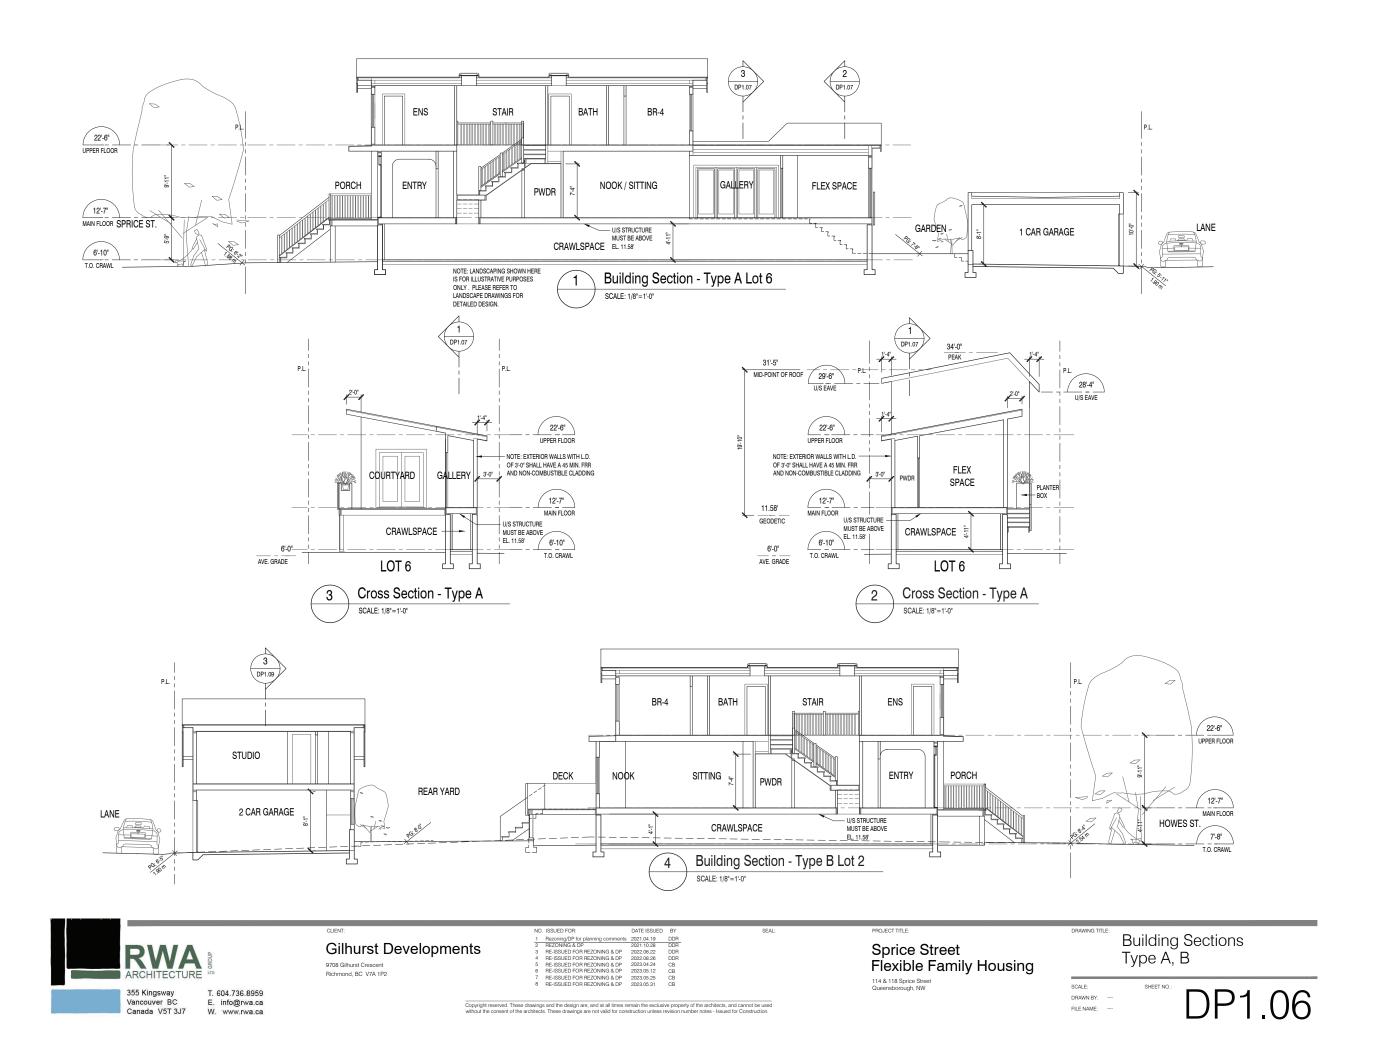


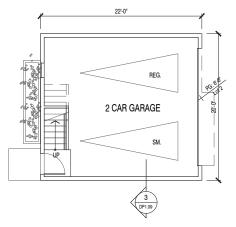



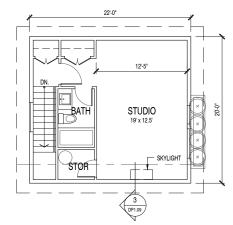


2 Upper Floor / Studio Plan
SCALE: 1/8"=1'-0" 440 sf

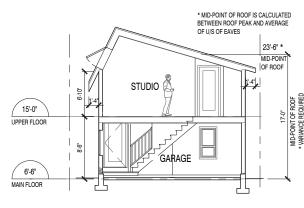


Scale: 1/8"=1'.0"


E. info@rwa.ca

W. www.rwa.ca

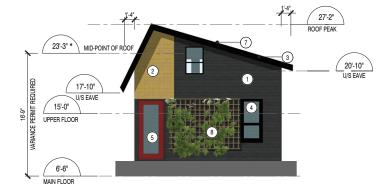




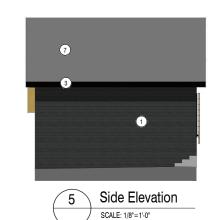

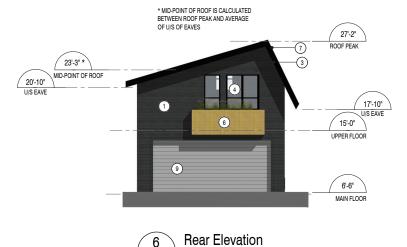

SCALE: 1/8"=1'-0"

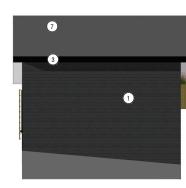

7 Side Elevation SCALE: 1/8"=1'-0"

MATERIAL LEGEND:

- ① *HORIZONTAL SIDING 1X6 LAPPED COMPOSITE BOARD
- ② STAINED WOOD PANELLING
- ③ 2x8 FASCIA
- (4) *VINYL WINDOWS
- (5) RED GLAZED DOOR
- 6 STAINED WOOD PLANTER
- © GREY ASPHALT SHINGLES
- ® STAINED WOOD TRELLIS
- 9 PAINTED METAL OVERHEAD DOOR

NOTE

CLADDING AND WINDOW FRAME COLOURS VARY WITH THE COLOUR COMBINATIONS NOTED WITH AN * - REFER TO DP 1.09 FOR DETAILS ON COLOUR AND MATERIAL COMBINATIONS



Canada V5T 3J7

Gilhurst Developments
9708 Gilhurst Crescent
Richmond, BC V7A 1P2

Sprice Street Flexible Family Housing 114 & 118 Sprice Street Ouensborough, NW Studio/Garage - w/ Height Variance Plans, Section, Elevations

SCALE: SHEET NO DRAWN BY: ---FILE NAME: ----



COMBINATION 1 - ALL TYPE A UNITS

- STAINED WOOD BATTENS ON COMPOSITE BOARD
 WHITE HORIZONTAL SIDING
- BLACK VINYL WINDOW FRAMES
- BLACK PAINTED WOOD PAILINGS
 BLACK PAINTED WOOD PORCH FASCIA
 DECORATIVE BLACK PAINTED WOOD FRONT ENTRY SURROUND
- CHARCOAL HORIZONTAL SIDING BELOW MAIN FLOOR LEVEL
- CHARCOAL STAINED WOOD DOOR W/ VERTICAL GLAZING GARAGE WHITE HORIZONTAL SIDING

COMBINATION 2

- LIGHT GREY COMPOSITE BOARD WITH BATTENS
 WHITE HORIZONTAL SIDING
- CHARCOAL HORIZONTAL SIDING
- WHITE VINYL WINDOW FRAMES WHITE PAINTED WOOD RAILINGS
- BLACK PAINTED WOOD PORCH FASCIA DECORATIVE BLACK PAINTED WOOD FRONT ENTRY
- SURROUND
 CHARCOAL HORIZONTAL SIDING BELOW MAIN FLOOR LEVEL
 RED PAINTED WOOD DOOR W/ GLAZING
- GARAGE CHARCOAL HORIZONTAL SIDING

COMBINATION 3

- LIGHT GREY COMPOSITE BOARD WITH BATTENS
 WHITE HORIZONTAL SIDING
 STAINED WOOD BATTENS ON COMPOSITE BOARD
- BLACK VINYL WINDOW FRAMES BLACK PAINTED WOOD RAILINGS BLACK PAINTED WOOD PORCH FASCIA
- DECORATIVE BLACK PAINTED WOOD FRONT ENTRY SURROUND
- CHARCOAL PAINTED WOOD FROM ENTRY SURROUN
 CHARCOAL PAINTED WOOD DOOR W GLAZING
 GARAGE CHARCOAL HORIZONTAL SIDING
 GARAGE CHARCOAL HORIZONTAL SIDING

- CHARCOAL HORIZONTAL SIDING
 WHITE HORIZONTAL SIDING STAINED WOOD BATTENS ON COMPOSITE BOARD
- BLACK VIYL WINDOW FRAMES
 WHITE PAINTED WOOD RAILINGS
 WHITE PAINTED WOOD PORCH FASCIA
- DECORATIVE BLACK PAINTED WOOD FRONT ENTRY SURROLIND
- DECORATIVE BLACK PAINTED WOOD FRONT ENTITY SORROOM
 CHARCOAL HORIZONTAL SIDING BELOW MAIN FLOOR LEVEL
 TEAL PAINTED WOOD DOOR W/ VERTICAL GLAZING
 GARAGE WHITE HORIZONTAL SIDING

COMBINATION5

- DARK GREY COMPOSITE BOARD WITH BATTENS
 WHITE HORIZONTAL SIDING
- BLACK WINDOW FRAMES
- BLACK PAINTED RAILINGS
 BLACK PAINTED PORCH FASCIA
 DECORATIVE BLACK PAINTED WOODFRONT ENTRY SURROUND CHARCOAL HORIZONTAL SIDING BELOW MAIN FLOOR LEVEL
- NATURAL STAINED WOOD DOOR W/ VERTICAL GLAZING GARAGE CHARCOAL HORIZONTAL SIDING

MATERIAL AND COLOUR LEGEND DETAILS:

- (1) WHITE HORIZONTAL SIDING 1X6 LAPPED COMPOSITE BOARD
- (2) CHARCOAL HORIZONTAL SIDING 1X6 LAPPED COMPOSITE BOARD
- (3) LIGHT GREY COMPOSITE PANEL W/ BATTENS ALIGNED WITH WINDOW FRAMES
- (4) DARK GREY COMPOSITE PANEL W/ BATTENS ALIGNED WITH WINDOW FRAMES (5) 1X4 STAINED WOOD BATTENS ON THE FLAT @ 4.5" CENTRES ON COMPOSITE

NOTE:

E. info@rwa.ca

W. www.rwa.ca

- MATERIAL 1 IS THE BASE MATERIAL AND IS NOT LABELLED BELOW ONLY THE "ACCENT" MATERIALS AND COLOURS 2-5 ARE INDICATED
- MATERIALS 2-5 ILLUSTRATED ON THE FRONT ELEVATIONS BELOW EXTEND 6 FT AROUND THE SIDE ELEVATIONS

THESE 5 COLOUR AND MATERIAL COMBINATIONS WILL BE DEVELOPED ON THE SPRICE AND HOWES STREETSCAPES. THE IMAGE ABOVE DEMONSTRATES THEIR USE ON SPRICE STREET. HOWES STREET WILL BE DEVELOPED WITH A "MIRRORED" VERSION OF THE ABOVE.



Canada V5T 3J7

Gilhurst Developments 9708 Gilhurst Crescent


Sprice Street Flexible Family Housing


114 & 118 Sprice Street Queensborough, NW

Material and Colour Combinations

SCALE: DRAWN BY: ----

Richmond, BC V7A 1P2

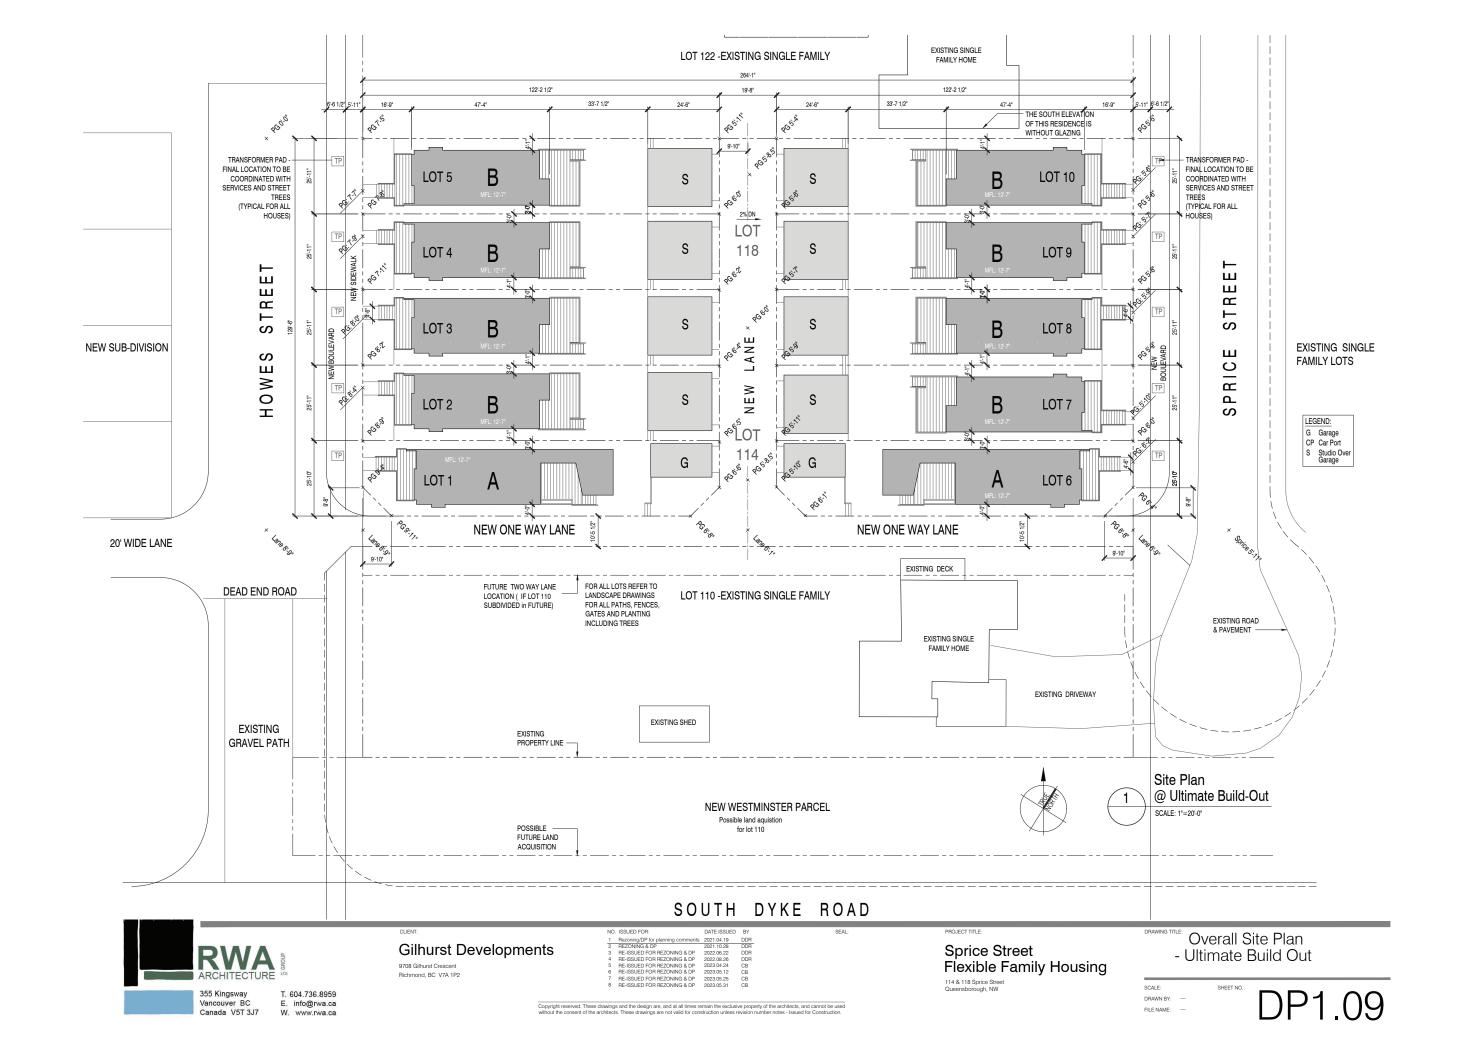

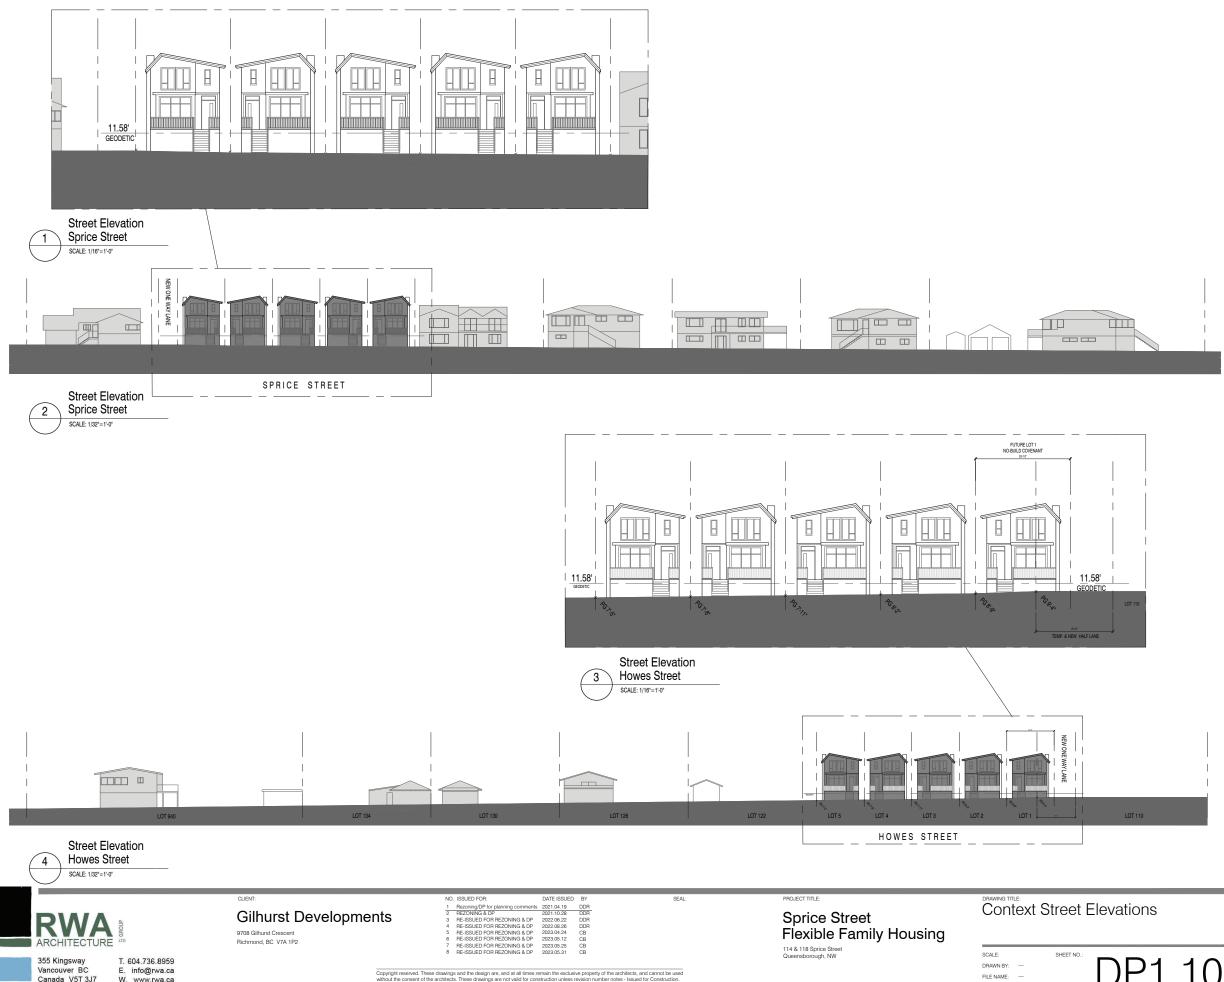

Vancouver BC Canada V5T 3J7

E. info@rwa.ca W. www.rwa.ca

DP1.10 FILE NAME: ----







T. 604.736.8959 E. info@rwa.ca W. www.rwa.ca 355 Kingsway Vancouver BC Canada V5T 3J7

Gilhurst Developments 9708 Gilhurst Crescent Richmond, BC V7A 1P2

_			
NO.	ISSUED FOR:	DATE ISSUED	BY
1	Rezoning/DP for planning comments	2021.04.19	DDR
2	REZONING & DP	2021.10.28	DDR
3	RE-ISSUED FOR REZONING & DP	2022.06.22	DDR
4	RE-ISSUED FOR REZONING & DP	2022.08.26	DDR
5	RE-ISSUED FOR REZONING & DP	2023.04.24	CB
6	RE-ISSUED FOR REZONING & DP	2023.05.12	CB
7	RE-ISSUED FOR REZONING & DP	2023.05.25	CB
8	RE-ISSUED FOR REZONING & DP	2023.05.31	CB

Sprice Street Flexible Family Housing

Illustrations - 3d Views

DP1.11



View Into Lane



Street Level View



T. 604.736.8959 E. info@rwa.ca W. www.rwa.ca

Gilhurst Developments 9708 Gilhurst Crescent Richmond, BC V7A 1P2

Sprice Street Flexible Family Housing

Illustrations - 3d Views

SCALE:
DRAWN BY: --FILE NAME: ---DP1.12



View Into Back Yards




Gilhurst Developments 9708 Gilhurst Crescent Richmond, BC V7A 1P2

Sprice Street Flexible Family Housing

Illustrations - 3d Views

DP1.13

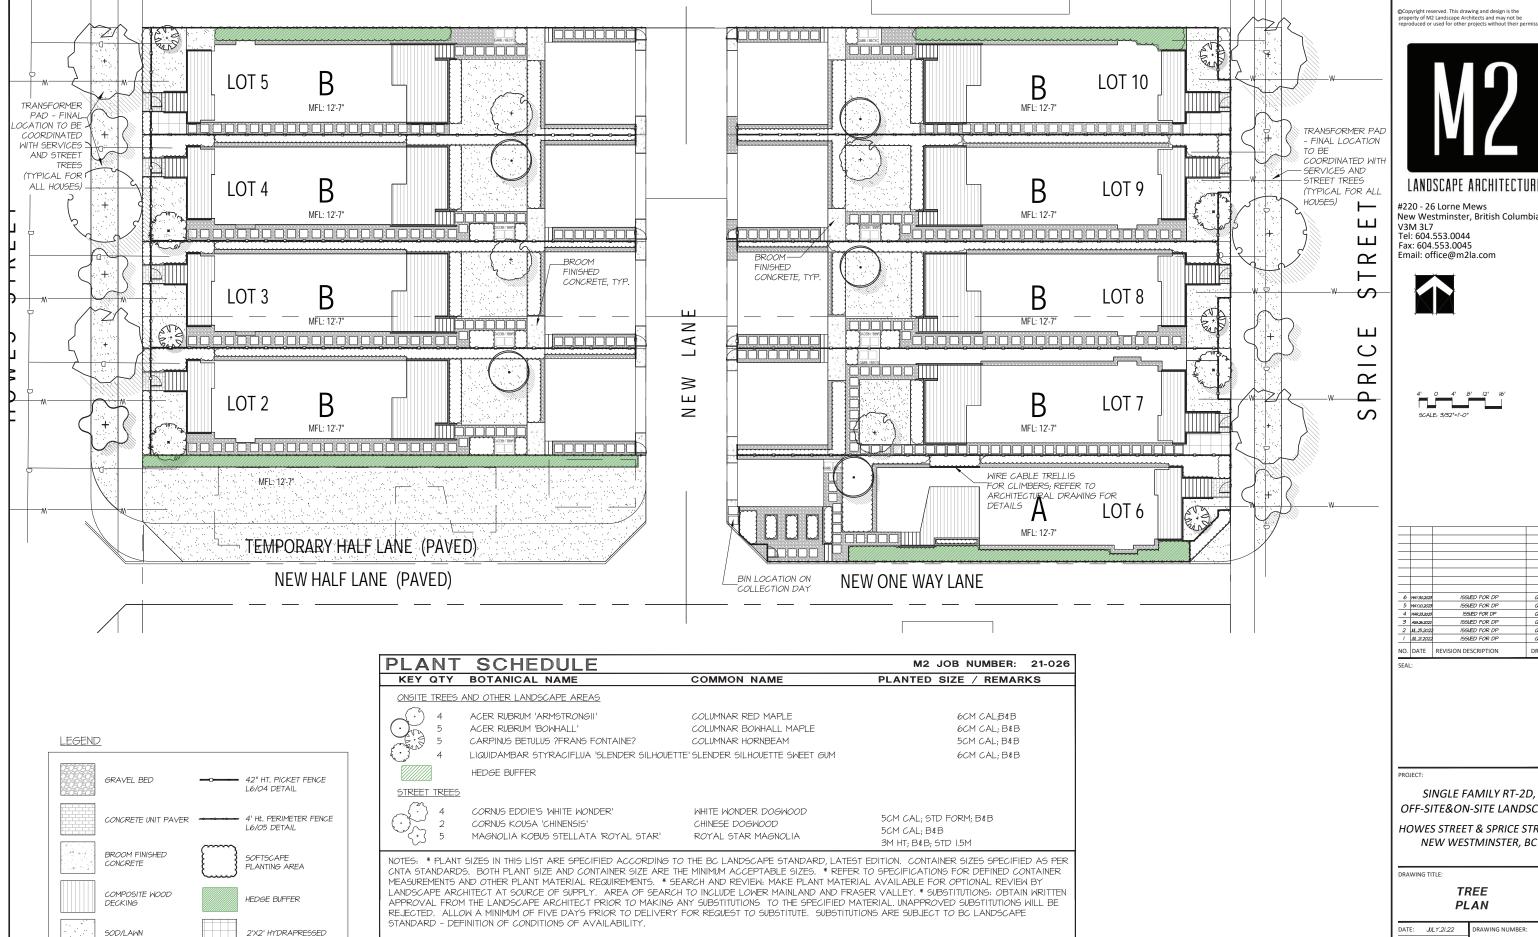

ALL PLANT MATERIAL MUST BE PROVIDED FROM CERTIFIED DISEASE FREE NURSERY. PROVIDE CERTIFICATION UPON REQUEST.

PAVER



LANDSCAPE ARCHITECTURE

#220 - 26 Lorne Mews New Westminster, British Columbia V3M 3L7 Tel: 604.553.0044 Fax: 604.553.0045 Email: office@m2la.com






		<u> </u>	
6	MAY.30,2023	ISSUED FOR DP	a
5	MAY.10.2023	ISSUED FOR DP	Q
4	MAR.23,2023	ISSUED FOR DP	Q
3	AUG.26.2022	ISSUED FOR DP	QL
2	JL.25.2022	ISSUED FOR DP	Q1
T	JUL 21.2022	ISSUED FOR DP	a
NO.	DATE	REVISION DESCRIPTION	DR.

OFF-SITE&ON-SITE LANDSCAPE HOWES STREET & SPRICE STREET,

TREE PLAN

DATE:	JULY.21.22	DRAWING NUMBER:
SCALE:	l' = 3/32"	
DRAWN:	QL	1 1
DESIGN:	QL	<u> </u>
CHK'D:	MTLM	OF 10
M2LA PRO	OJECT NUMBER:	21-026

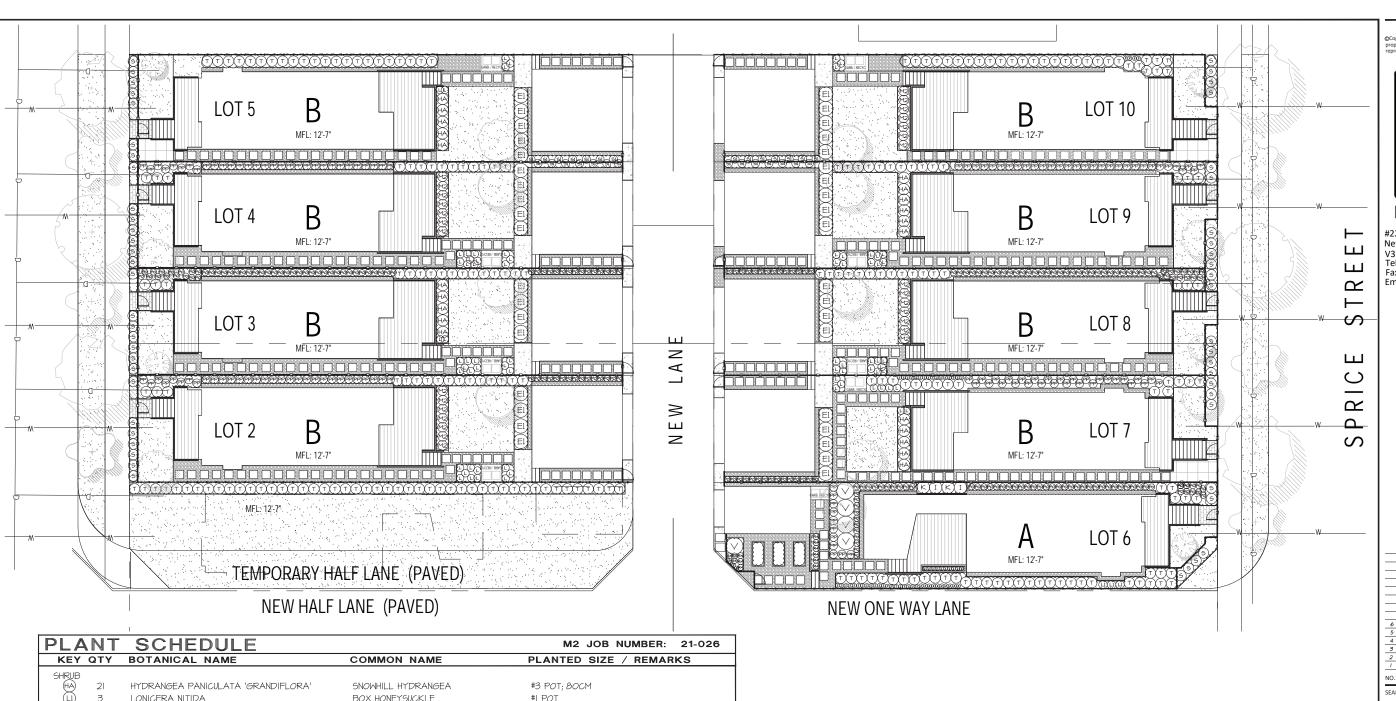

BOX HONEYSUCKLE LONICERA XYLOSTEOIDES 'CLAVEY'S DWARF' CLAVEY'S DWARF HONEYSUCKLE #I POT; 20CM 28 MAHONIA CHARITY PALM MAHONIA #2 POT 37 RHODODENDRON 'MAY DAY' RHODODENDRON; RED; MAY #2 POT 28 SARCOCOCCA HOOKERANA VAR. HUMILIS #2 POT HIMALAYAN SWEET BOX SPIRAEA X BUMALDA 'ANTHONY WATERER' JAPANESE SPIRAEA #2 POT \bigcirc 227 THUJA OCCIDENTALIS 'SMARAGD' EMERALD GREEN CEDAR 1.5 M B&B VIBURNUM DAVIDII DAVID'S VIBURNUM #2 POT; 30CM GRASS (z)DWARF FOUNTAIN GRASS PENNISETUM ALOPECUROIDES 'HAMELIN' VINE K) 2 PERENNIAL BOSTON IVY #2 POT; 60CM; STAKED PARTHENOCISSUS TRICUSPIDATA 'VEITCHII' L R4 LAVENDULA ANGUSTIFOLIA ENGLISH LAVENDER RUDBECKIA FULGIDA VAR SULLIVANTII 'GOLDILOCKBUDBECKIA #I POT GC 204 #I POT; 25CM BLECHNUM SPICANT DEER FERN 133 WESTERN SWORD FERN #2 POT; 40CM

NOTES: * PLANT SIZES IN THIS LIST ARE SPECIFIED ACCORDING TO THE BC LANDSCAPE STANDARD, LATEST EDITION. CONTAINER SIZES SPECIFIED AS PER CNTA STANDARDS. BOTH PLANT SIZE AND CONTAINER SIZE ARE THE MINIMUM ACCEPTABLE SIZES. * REFER TO SPECIFICATIONS FOR DEFINED CONTAINER MEASUREMENTS AND OTHER PLANT MATERIAL REQUIREMENTS. * SEARCH AND REVIEW: MAKE PLANT MATERIAL AVAILABLE FOR OPTIONAL REVIEW BY LANDSCAPE ARCHITECT AT SOURCE OF SUPPLY. AREA OF SEARCH TO INCLUDE LOWER MAINLAND AND FRASER VALLEY. * SUBSTITUTIONS: OBTAIN WRITTEN APPROVAL FROM THE LANDSCAPE ARCHITECT PRIOR TO MAKING ANY SUBSTITUTIONS TO THE SPECIFIED MATERIAL. UNAPPROVED SUBSTITUTIONS WILL BE REJECTED. ALLOW A MINIMUM OF FIVE DAYS PRIOR TO DELIVERY FOR REQUEST TO SUBSTITUTE. SUBSTITUTIONS ARE SUBJECT TO BC LANDSCAPE STANDARD - DEFINITION OF CONDITIONS OF AVAILABILITY.

ALL PLANT MATERIAL MUST BE PROVIDED FROM CERTIFIED DISEASE FREE NURSERY. PROVIDE CERTIFICATION UPON REQUEST.

©Copyright reserved. This drawing and design is the property of M2 Landscape Architects and may not be



LANDSCAPE ARCHITECTURE

#220 - 26 Lorne Mews New Westminster, British Columbia V3M 3L7 Tel: 604.553.0044 Fax: 604.553.0045 Email: office@m2la.com





_			
_			
_			
-6	MAY.50.2025	ISSUED FOR DP	- 6
_	MAY,10,2023	ISSUED FOR DP	6
_	MAR.25.2025	ISSUED FOR DP	6
3	AU6,26,2022	ISSUED FOR DP	- 6
2	JL.25.2022	ISSUED FOR DP	6
-1	JUL 21.2022	ISSUED FOR DP	G
	DATE	REVISION DESCRIPTION	DR

PROJEC


SINGLE FAMILY RT-2D,
OFF-SITE&ON-SITE LANDSCAPE
HOWES STREET & SPRICE STREET,

NEW WESTMINSTER, BC

DRAWING TITLE:

SHRUB PLAN

	DATE: JULY.21.22	DRAWING NUMBER:	
	SCALE: I' = 3/32"		
	DRAWN: QL	12	
	DESIGN: QL		
	CHK'D: MTLM	OF 1	
,	M2LA PROJECT NUMBER:	21-02	

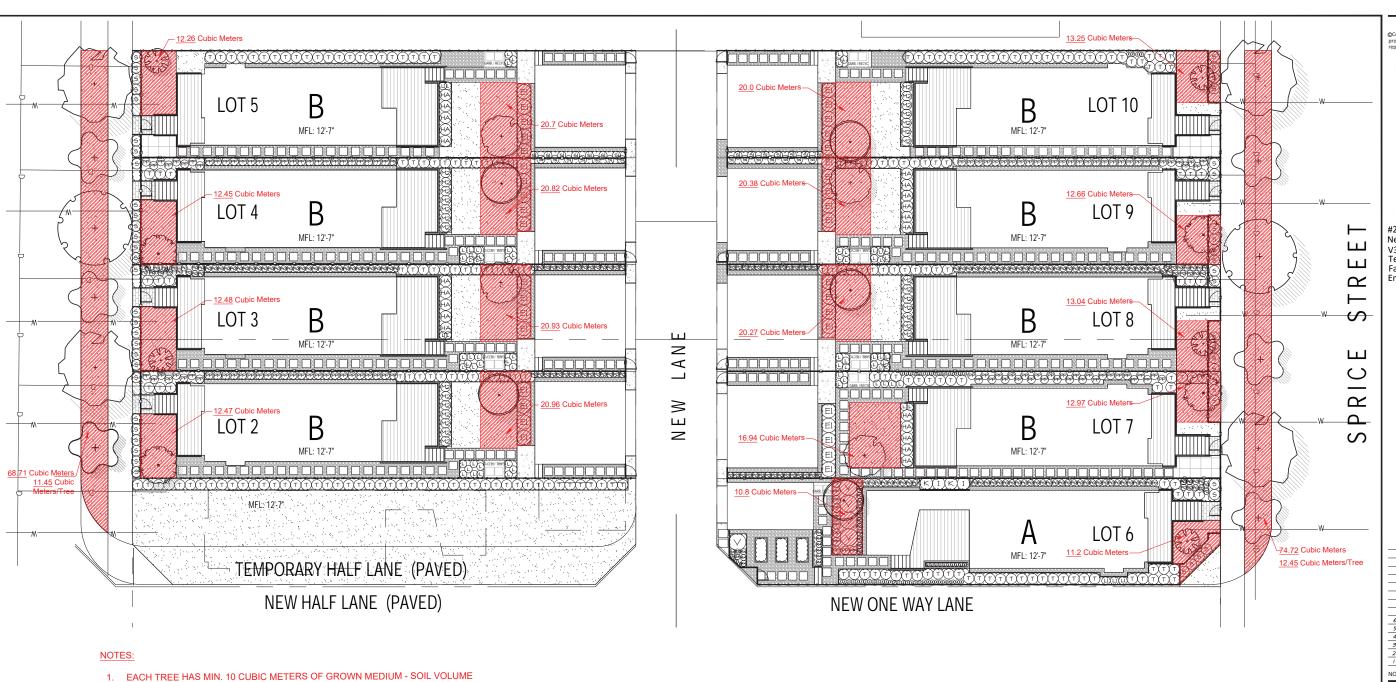


2. STREET TREES ARE CONNECTED WITH CONTINUED SOIL TRENCH



LANDSCAPE ARCHITECTURE

#220 - 26 Lorne Mews New Westminster, British Columbia V3M 3L7 Tel: 604.553.0044 Fax: 604.553.0045 Email: office@m2la.com



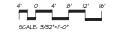

6	MAY.30,2023	ISSUED FOR DP	a
5	MAY.10.2023	ISSUED FOR DP	a
4	MAR.23,2023	ISSUED FOR DP	a
3	AU6.26.2022	ISSUED FOR DP	a
2	JL.25.2022	ISSUED FOR DP	a
- 1	JUL 21.2022	ISSUED FOR DP	a
NO.	DATE	REVISION DESCRIPTION	DR

PROJECT:

SINGLE FAMILY RT-2D, OFF-SITE&ON-SITE LANDSCAPE HOWES STREET & SPRICE STREET,

NEW WESTMINSTER, BC


DRAWING TITLE:

SOIL VOLUME PLAN

DATE: JULY.21.22 DRAWING NUMBER: SCALE: 1' = 3/32" L3 DRAWN: QL DESIGN: QL CHK'D: MTLM OF 10

M2LA PROJECT NUMBER:

21-026

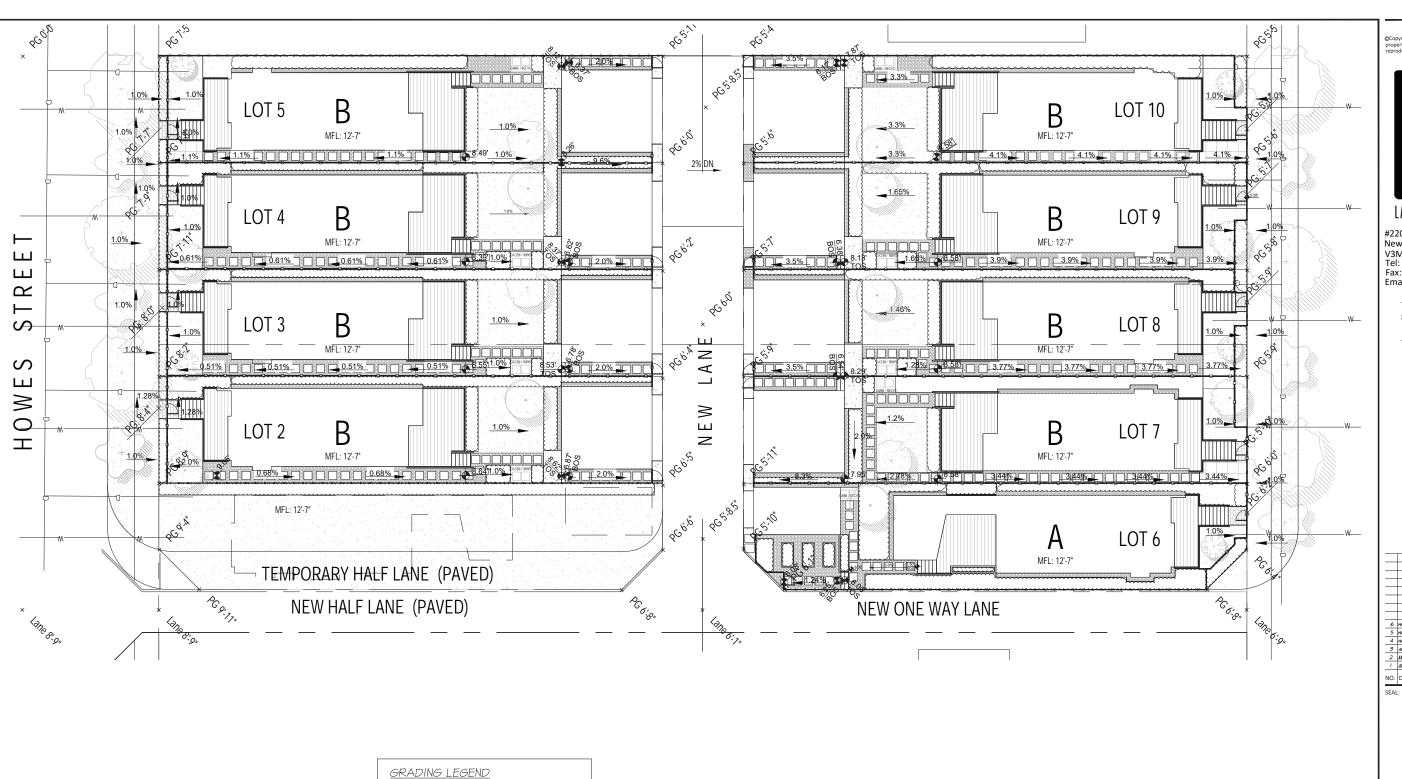

4.00% PERCENTAGE OF SLOPE BOSTOM OF STEPS

6.50' PROPOSED FINISH GRADE

6.50' TOP OF STEPS



LANDSCAPE ARCHITECTURE

#220 - 26 Lorne Mews New Westminster, British Columbia V3M 3L7 Tel: 604.553.0044 Fax: 604.553.0045 Email: office@m2la.com





6	MAY.30,2023	ISSUED FOR DP	a
5	MAY.10.2023	ISSUED FOR DP	a
4	MAR.25,2023	ISSUED FOR DP	a
3	AUG.26.2022	ISSUED FOR DP	a
2	JL.25.2022	ISSUED FOR DP	a
1	JUL 21.2022	ISSUED FOR DP	a
NO.	DATE	REVISION DESCRIPTION	DR

SINGLE FAMILY RT-2D, OFF-SITE&ON-SITE LANDSCAPE

HOWES STREET & SPRICE STREET, NEW WESTMINSTER, BC

DRAWING TITLE:

GRADING PLAN

DATE: JULY.21.22	DRAWING NUMBER:
SCALE: I' = 3/32"	
DRAWN: QL	1 4
DESIGN: QL	<u> </u>
CHK'D: MTLM	a
 MAZI A DROJECT NIJIMBED:	21-1



LIGHTING

PLAN

DRAWING NUMBER:

L5

ISSUED FOR DE ISSUED FOR DI ISSUED FOR DP ISSUED FOR DP ISSUED FOR DP

M2LA PROJECT NUMBER:

21-026



©Copyright reserved. This drawing and design is the property of M2 Landscape Architects and may not be



LANDSCAPE ARCHITECTURE

#220 - 26 Lorne Mews New Westminster, British Columbia V3M 3L7 Tel: 604.553.0044 Fax: 604.553.0045 Email: office@m2la.com





6	MAY.30,2023	ISSUED FOR DP	0
5	MAY.10.2023	ISSUED FOR DP	6
4	MAR.23,2023	ISSUED FOR DP	G
3	AU6.26.2022	ISSUED FOR DP	6
2	JL.25.2022	ISSUED FOR DP	G
- 1	JUL.21.2022	ISSUED FOR DP	6
NO.	DATE	REVISION DESCRIPTION	DF

SE

PROJECT

SINGLE FAMILY RT-2D, OFF-SITE&ON-SITE LANDSCAPE HOWES STREET & SPRICE STREET,

NEW WESTMINSTER, BC

DRAWING TITLE

IMPERVIOUS V.S. PERVIOUS
CALCULATION PLAN


DATE: JULY.21.22	DRAWING NUMBER:
SCALE: I' = 3/32"	
DRAWN: QL	16
DESIGN: QL	
CHK'D: MTLM	OF 10
M2LA PROJECT NUMBER:	21-026

PERVIOUS V.S. IMPERVIOUS PAVING AREA WITHIN THE TWO LOTS



TOTAL TWO LOTS AREA: 30349 s.f.

TOTAL PERVIOUS
AREA/TWO LOTS
AREA:
41.0%

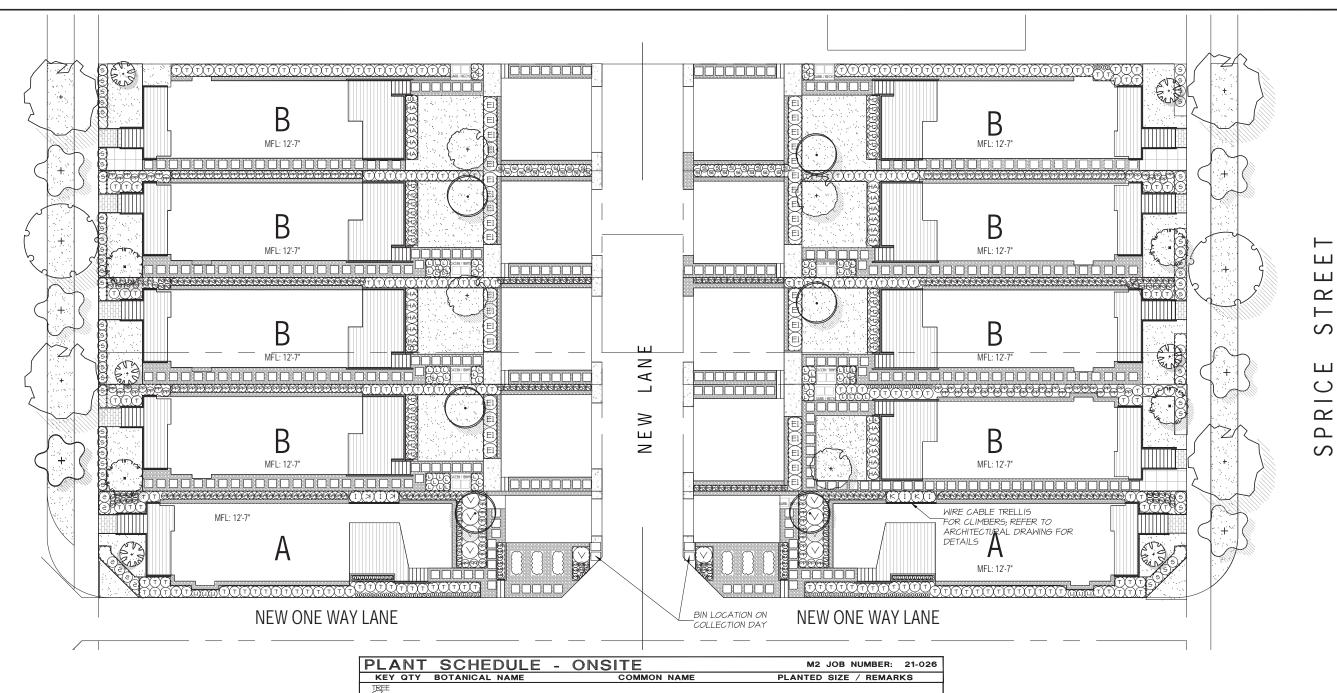

LEGEND 42" HT. PICKET FENCE GRAVEL BED L6/04 DETAIL CONCRETE UNIT PAVER -4' Ht. PERIMETER FENCE L6/05 DETAIL BROOM FINISHED SOFTSCAPE CONCRETE PLANTING AREA COMPOSITE WOOD 2'X2' HYDRAPRESSED DECKING PAVER SOD/LAWN

	·		
4	ACER RUBRUM 'ARMSTRONGII'	COLUMNAR RED MAPLE	6CM CAL;B&B
6	ACER RUBRUM 'BOWHALL'	COLUMNAR BOWHALL MAPLE	6CM CAL; B∉B
6	CARPINUS BETULUS ?FRANS FONTAINE?	COLUMNAR HORNBEAM	5CM CAL; B&B
4	LIQUIDAMBAR STYRACIFLUA 'SLENDER SILHOUET	TE'SLENDER SILHOUETTE SWEET GUM	6CM CAL; B&B
-		SUCCESSION AND AND A	112 DOT 00014
			#3 POT; 80CM
			#I POT
			, ==
			#2 POT
			#2 POT
59	SPIRAEA X BUMALDA 'ANTHONY WATERER'		#2 POT
25	THUJA OCCIDENTALIS 'SMARAGD'	EMERALD GREEN CEDAR	I.5 M B∉B
0	VIBURNUM DAVIDII	DAVID'S VIBURNUM	#2 POT; 30CM
28	PENNISETUM ALOPECUROIDES 'HAMELIN'	DWARF FOUNTAIN GRASS	#I POT
	PARTHENOCISSUS TRICUSPIDATA VEITCHII'	BOSTON IVY	#2 POT; 60CM; STAKED
	LA ENOUGA ANGUCTIONA	EVELICITE A FUDED	#1 507
			#I POT
24	RUDBECKIA FULGIDA VAR SULLIVANTII GOLDILO	DCKBUDBECKIA	#I POT
276	BLECHNUM SPICANT	DEER FERN	#I POT: 25CM
44			#2 POT: 40CM
	6 6 6 4 21 6 4 4 22 8 5 9 7 9 9 9 9 9 9 9 9 9 9 9 9 9 9 9 9 9	ACER RUBRUM 'BOWHALL' CARPINUS BETULUS ?FRANS FONTAINE? LIQUIDAMBAR STYRACIFLUA 'SLENDER SILHOUET HYDRANGEA PANICULATA 'GRANDIFLORA' LONICERA NITIDA LONICERA XYLOSTEOIDES 'CLAVEY'S DWARF' RHODODENDRON 'MAY DAY' SARCOCOCCA HOOKERANA VAR. HUMILIS SPIRAEA X BUMALDA 'ANTHONY WATERER' THUJA OCCIDENTALIS 'SMARAGD' VIBURNUM DAVIDII PENNISETUM ALOPECUROIDES 'HAMELIN' PARTHENOCISSUS TRICUSPIDATA 'VEITCHII' LAVENDULA ANGUSTIFOLIA RUDBECKIA FULGIDA VAR SULLIVANTII 'GOLDILC	ACER RUBRUM 'BOWHALL' CARPINUS BETULUS 'FRANS FONTAINE? LIQUIDAMBAR STYRACIFLUA 'SLENDER SILHOUETTE' SLENDER SILHOUETTE SWEET GUM HYDRANGEA PANICULATA 'GRANDIFLORA' LONICERA NITIDA LONICERA NITIDA LONICERA XYLOSTEOIDES 'CLAVEY'S DWARF' HADOODENDRON 'MAY DAY' SARCOCOCCA HOOKERANA VAR. HUMILIS SPIRAEA X BUMALDA 'ANTHONY WATERER' THUJA OCCIDENTALIS 'SMARAGD' VIBURNUM DAVIDII DWARF FOUNTAIN GRASS PARTHENOCISSUS TRICUSPIDATA 'VEITCHII' BOSTON IVY LAVENDULA ANGUSTIFOLIA RUDBECKIA FULGIDA VAR SULLIVANTII 'GOLDILOCKBUDBECKIA BLECHNUM SPICANT DEER FERN

MEASUREMENTS AND OTHER FLANT MATERIAL REQUIREMENTS. * SEARCH AND REVIEW MALE PLANT MATERIAL AVAILABLE FOR OFTIONAL REVIEW BY LANDSCAPE ARCHITECT AT SOURCE OF SUPPLY. AREA OF SEARCH TO INCLUDE LOWER MAINLAND AND FRASER VALLEY. * SUBSTITUTIONS: OBTAIN WRITTEN APPROVAL FROM THE LANDSCAPE ARCHITECT PRIOR TO MAKING ANY SUBSTITUTIONS TO THE SPECIFIED MATERIAL. UNAPPROVED SUBSTITUTIONS WILL BE REJECTED. ALLOW A MINIMUM OF FIVE DAYS PRIOR TO DELIVERY FOR REQUEST TO SUBSTITUTIONS ARE SUBJECT TO BC LANDSCAPE STANDARD - DEFINITION OF CONDITIONS OF AVAILABILITY.



LANDSCAPE ARCHITECTURE

#220 - 26 Lorne Mews New Westminster, British Columbia V3M 3L7 Tel: 604.553.0044 Fax: 604.553.0045 Email: office@m2la.com





6	MAY.30,2023	ISSUED FOR DP	QL
5	MAY.10.2023	ISSUED FOR DP	QL
4	MAR.23.2023	ISSUED FOR DP	QL
3	AUG.26.2022	ISSUED FOR DP	QL
2	JL.25.2022	ISSUED FOR DP	QL
	JUL.21.2022	ISSUED FOR DP	QL
NO.	DATE	REVISION DESCRIPTION	DR.

PROJECT:


SINGLE FAMILY RT-2D, OFF-SITE&ON-SITE LANDSCAPE HOWES STREET & SPRICE STREET,

NEW WESTMINSTER, BC

DRAWING TITLE:

FULL BUILD PLAN

	DATE: JULY.21.22	DRAWING NUMBER:		
	SCALE: I' = 3/32"			
	DRAWN: QL	17		
	DESIGN: QL			
	CHK'D: MTLM	OF 1		
ю	M2LA PROJECT NUMBER:	21-02		

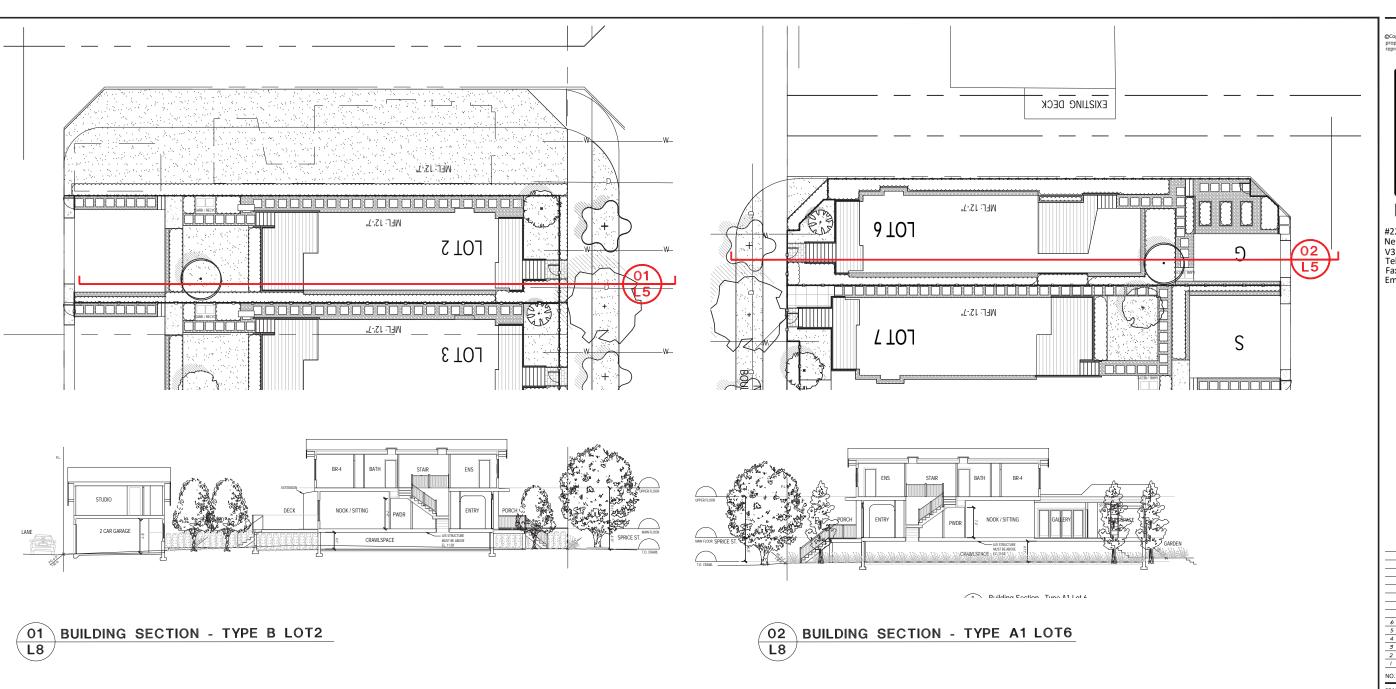



LANDSCAPE ARCHITECTURE

#220 - 26 Lorne Mews New Westminster, British Columbia V3M 3L7 Tel: 604.553.0044 Fax: 604.553.0045 Email: office@m2la.com



_			
_			
_			\neg
_			
_			
6	MAY.30.2023	ISSUED FOR DP	a
5	MAY.10.2023	ISSUED FOR DP	a
4	MAR.25.2023	ISSUED FOR DP	a
3	AUG.26.2022	ISSUED FOR DP	a
2	JL.25.2022	ISSUED FOR DP	a
-1	JUL 21.2022	ISSUED FOR DP	a
NO.	DATE	REVISION DESCRIPTION	DR

PROJECT:


SINGLE FAMILY RT-2D, OFF-SITE&ON-SITE LANDSCAPE HOWES STREET & SPRICE STREET,


NEW WESTMINSTER, BC

DRAWING TITLE:

LANDSCAPE ELEVATIONS

DATE:	07.21.22	DRAWING NUMBER:
SCALE:	1' = 3/32"	
DRAWN:	QL .	18
DESIGN:	QL	
CHK'D:	MTLM	OF 1
		~ ~ ~

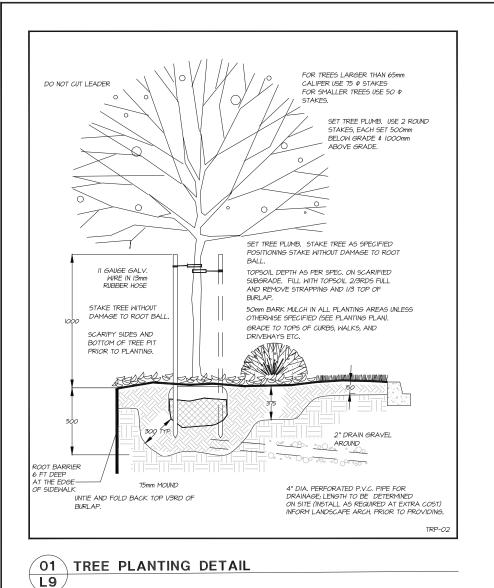


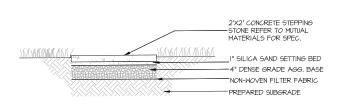


CONCRETE STEPPING STONE L9

03 DRAIN ROCK STRIP AGAINST BUILDING

L9

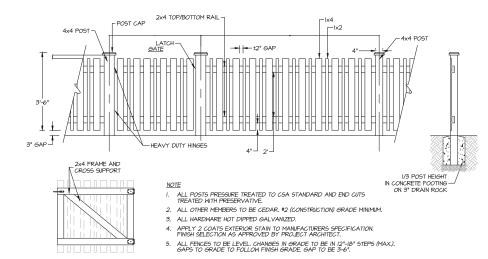


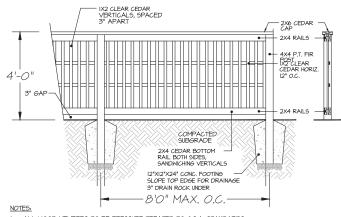

- ALL WOOD MEMBERS TO BE PRESSURE TREATED TO C.S.A. STANDARDS
- ALL HARDWARE TO BE HOT-DIPPED GALVANIZED
- APPLY TWO COATS OF STAIN TO MATCH BUILDING (TO BE APPROVED BY
- OWNER OR LANDSCAPE ARCHITECT)
 4. COAT ALL CUT SURFACES WITH SIMILAR PRESERVATIVE AS ABOVE


42" PICKET FENCE AND GATE L9

05 4 FT. HEIGHT PERIMETER FENCE L9

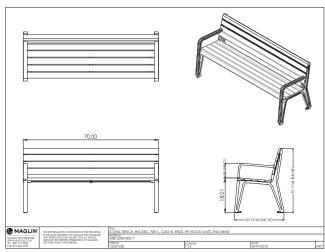


L9 BENCH

06 FRANCIS ANDREWS FURNISHINGS

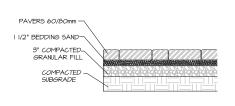


CONCRETE UNIT PAVERS AT L9 / GRADE

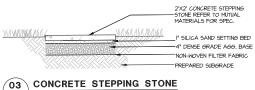

L5 SCALE NTS

CONCRETE STEPPING STONE AT L9 / GRADE

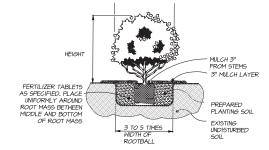

SHRUB PLANTING DETAIL L9

-2'X2' HYDRAPRESSED CONCRETE SLAB -- I" SAND SETTING BED COMPACTED AGGREGATE BASE COMPACTED SOIL

HYDRAPRESSED CONCRETE L9 PAVERS AT GRADE

PROJECT:

SINGLE FAMILY RT-2D, OFF-SITE&ON-SITE LANDSCAPE HOWES STREET & SPRICE STREET, NEW WESTMINSTER, BC

ISSUED FOR DI ISSUED FOR DI ISSUED FOR DP

DR.

NO. DATE REVISION DESCRIPTION

LANDSCAPE ARCHITECTURE

New Westminster, British Columbia

#220 - 26 Lorne Mews

Fax: 604.553.0045 Email: office@m2la.com

Tel: 604.553.0044

V3M 3L7

DRAWING TITLE:

LANDSCAPE **DETAILS**

DATE: 09.10.21 DRAWING NUMBER: SCALE: AS SHOWN 9 DRAWN: QL DESIGN: QL CHK'D: MTLM

SCORE CUT CONCRETE AT L9 / GRADE

M2LA PROJECT NUMBER:

21-026

PART ONE GENERAL REQUIREMENTS

.1 CCDC Doc 2 2008

Comply with all articles in the General Conditions of Contract in conjunction with this section unless superseded by other Contract Documents.

2 B.C. Landscape Standard, 7th edition 2008, prepared by the B.C. Society of Landscape Architects and the B.C. Landscape & Nursery Association, jointly. All work and shall meet standards as set out in the B.C. Landscape Standard unless superseded by this specification or as directed by Landscape Architect with written instruction.

3 MASTER MUNICIPAL SPECIFICATIONS & STANDARD DETAILS, 2000 edition, prepared by the Consulting Engineers of British Columbia, Roadbuilders and Heavy Construction

- .4 STANDARD FOR LANDSCAPE IRRIGATION SYSTEM. 2008: Prepared by the Irrigation Industry Association of British Columbia
- .5 MUNICIPAL BYLAWS AND ENGINEERING SPECIFICATIONS WHERE NOTED.

.1. A current finet more than one month) test for all growing medium to be used on this site is required. Provide and pay for testing by an independent testing facility pre-approved by the Landscape Architect. Deliver growing medium test results to Landscape Architect for review and approval prior to placement. Refer to Section 3 Medium Testing for procedure.

.2 Owner reserves the right to test or re-test materials. Contractor responsible to pay for testing if materials do not meet specification.

SUBMITTALS

.1 Any alternate products differing from that contained in the contract documents must be pre-approved by the Landscape Architec

.2 Submittals to consist of product sample or manufacturer's product description

In text use.

1. Under the terms of the Landscape Architect's Contract with the Ouner and where the Landscape Architect is the designated reviewer, the Landscape Architect will observe construction as is necessary in their opinion to confirm conformance to the plans and specifications. Contact Owners Representative to arrange for site observation at the appropriate time. Allow the days notice. Observations schedule may include but will not be limited to the following.

1.1 Start Up Site Refetting, General Contract Prior to any site disturbance, a neeting with the general contractor to review tree preservation issues, general landscape issues.

and municipal requirements.
1.2 Start by Site Meeting, Landscape Contract lif separate). At the start of work with Owner's Representative, Site Superintendent and Landscape Contractor; a meeting is to be held to review expected work and to verify the acceptability of the subgrade and general site conditions to the Landscape Contractor. Provide growing medium test results

to held of a review expected worn and to ventry the exciptability of the sudge and general size combination to the Landscape contrastor. Proving groups meaning the combination of the c

Lettricate of compensor upon the decization of substrains reformance, a recommensation for the substract of the Certificate of Compensor upon the contract.
 Deficiency Review Prior to the compelsion of the holdback period, check for completion of deficiencies. Once completed, a Schedule C' will be issed where required.
 Positive Prior to the completion of the warranty period Iv/- 11 months after issuance of the Certificate of Completion, review all warranty material and report recommendations for warranty replacement.

WORKMANSHIP

.1 Unless otherwise instructed in the Contract Documents, the preparation of the subgrade shall be the responsibility of the General Contractor. Placement of growing medium constitutes acceptance of the subgrade by the Landscape Contractor. Any subsequent corrections to the subgrade required are the responsibility of the Landscape Contractor.

2. All work and superintendence shall be performed by personnel skilled in landscape contracting. In addition, all personnel applying herbicides and/or pesticides shall hold current license issued by the appropriate authorities.

.3 A site visit is required to become familiar with site conditions before bidding and before start of worl

- .5 Notify Landscape Architect of any discrepancies. Obtain approval from Landscape Architect prior to deviating from the plans

6 Take appropriate measures to avoid environmental damage. Do not dump any waste materials into water bodies. Conform with all federal provincial and local statutes and

7. Collect and dispose of all debris and/or excess material from landscape operations. Keep paved surfaces clean and repair damage resulting from landscape work. Repairs are to be completed prior to final acceptance.

.8 Where new work connects with existing, and where existing work is altered, make good to match existing undisturbed condition

.1 Guarantee all materials and workmanship for a minimum period of one full year from the date of Certificate of Completion

.2 Refer to individual sections for specific warranties. PART TWO SCOPE OF WORK

- Work includes supply of all related items and performing all operations necessary to complete the work in accordance with the drawings and specifications and generally consists of the following:

- .2.1 Retention of Existing Trees where shown on drawings.
 .2.2 Finish Grading and Landscape Drainage.
 .2.3 Supply and placement of growing medium.
 .2.4 Testing of imported growing medium and/or site topsoil,
 .2.5 Supply and incorporation of additives to meet requirement nts of soil test and Table One.

- 2.8 Preparation of rawn area, suppry or instriction amplements.
 2.9 Supply and placement of bark mulch.
 2.10 Haintenance of planted and seeded/sodded areas until accepted by Owner.
 2.11 SEPARATE PROFE. Establishment Haintenance, Section 3.11.
 2.12 Other work: Work other than this list, not specified by Landscape Architect.

TABLE ONE: PROPERTIES OF GROWING MEDIUM FOR LEVEL 2 GROOMED AND LEVEL 3 MODERATE AREA:

Organic Content (interior) Acidity (pH):

.1 Growing Medium: Conform to BC Landscape Standard for definitions of imported and on-site topsoil. Refer to Table One below.

Applications	Low Traffic Areas. Trees and Large Shrubs	High Traffic Lawn Areas	Planting Areas and Planters
Growing Medium Types	2L	2H	2P
Texture		Percent Of Dry Weight of Total Growing Me	diun
Coarse Gravel: larger than 25mm	0 - 1%	0 - 1%	0 - 1%
All Gravel: larger than 2mm	0 - 5%	0 - 5%	0 - 5%
		Percent Of Dry Weight of Growing Medium Exclud	ing Gravel
Sand: larger than 0.05mm smaller than 2.0mm	50 - 80%	70 - 90%	40 - 80%
Silt: larger than 0.002mm smaller than 0.05mm	10 - 25%	0 - 15%	10 - 25%
Clay: smaller than 0.002mm	0 - 25%	0 - 15%	0 - 25%
Clay and Silt Combined	maximum 35%	maximum 15%	maximum 35%

- .2 Fertilizer: An organic and/or inorganic compound containing Nitrogen (N), Phosphate (25), and Potash (soluble 2) in proportions required by soil test
- 3 Line: Ground agricultural linestone. Meet requirements of the B.C. Landscape Standard
- 4. Organic Additive: Commercial compost product to the requirements of the B.C. Landscape Standard, 6th edition and pre-approved by the Lan suppliers: The Answer Garden Products, Fraser Richmond Soils & Fibre, Stream Organics Management.
- .5 Sand: Clean, washed pump sand to meet requirements of the B.C. Landscape Standard
- 6. Composted Bark Mulch: 10mm [3/8*] minus Fir/Hemlock bark chips and fines, free of chunks and sticks, dark brown in colour and free of all soil, stones, roots or other extraneous matter. Fresh orange in colour bark will be rejected.
- Herbicides and Pesticides: If used, must conform to all federal, provincial and local statutes. Appliers must hold current licenses issued by the appropriate
 the area

- .10 Drain Rock: Clean, round, inert, durable, and have a maximum size of 19mm and containing no material smaller than 10mm
- .11 Plant Material: To the requirements of the B.C. Landscape Standard. Refer to 3.9, Plants and Planting. All plant material must be provided from a certified disease free nursery. Provide proof of certification.
- .13 Supplier and installers of segmental block walls to provide engineered drawings for all walls: signed and sealed drawings for all walls, individually, in excess of 12m, or combinations of walls collectively in excess of 12m. Installations must be reviewed and signed off by Certified Professional Engineer; include cost of engineering services in
- .14 Miscellaneous: Any other material necessary to complete the project as shown on the drawings and described here

PART THREE SOFT LANDSCAPE DEVELOPMENT

- RETEXTION OF DOCTORS TRESS.

 3. Find to any own on our protect individual trees or plant groupings indicated as retained on landscape plans as vegetation retection areas.

 11 In some instances the Landscape Architect will lag frees or areas to remain. Discuss tree retention areas at a start-up neeling with the Landscape Architect.
- 2. A physical barrier must be installed to delineate cleaning boundaries. Refer to physical barrier detail. If detail not provided, comply with local municipal requir-
- 3 No machine travel through or within vegetation retention areas or under crowns of trees to be retained is allowed
- .5 Do not park, fuel or service vehicles within vegetation retention areas
- .6 No debris fires, clearing fires or trash burning shall be permitted within vegetation retention areas
- .7 No excavations, drain or service trenches nor any other disruption shall be permitted within vegetation retention areas without a review of the
- 9 Any damage to existing vegetation intended for preservation will be subject to evaluation by an LS.A. Certified Arborist using the "Guide for Plant Appraisal", Eighth Editi
- 2.1. Replacement planning of equivalent value to the disturbance will be required. The cost of the evaluation and of the replacement planning will be the responsible of the replacement planning will be the replacement p
- .11 In situations where required construction may disturb existing vegetation intended for preservation, contact Landscape Architect for review prior to commencing

- .1 Ensure subgrade is prepared to conform to depths specified in Section 3.5, Growing Medium Supply, below. Where planting is indicated close to existing trees, prepa suitable planting pockets for material indicated on the planting plan. Shape subgrade to eliminate free standing water and conform to the site grading and drainage pla
- .2 On slopes in excess of 3:1 trench subgrade across slope to 150nm (6*) minimum at 1.5m (5 ft.) intervals minimum.
- 3. Scarify the entire subgrade immediately prior to placing growing medium. Re-cultivate where vehicular traffic results in compaction during the construction properties at all algaling areas are smoothly confoured after light compaction to finished grades.
- 4. Eliminate standing water from all finished grades. Provide a smooth, firm and even surface and conform to grades shown on the Landscape Drawings. Do not e maximum and minimum gradients defined by the B.C. Landscape Standard.
- 5 Construct swales true to line and grade, smooth and free of sags or high points. Minimum slope 2%, maximum side slopes 10%. Assure positive drainage to c
- .6 Slope not to exceed the following maximums: Rough Grass 3:1, Lawn 4:1, Landscape plantings 2:1
- Finished soil/mulch elevation at building to comply with municipal requirements.

Related Work: Growing medium and Finish Grading, Grass areas, Trees Shrubs and Groundcovers, Planters, Crib Walls,

.8 Inform Landscape Architect of completion of finish grade prior to placement of seed, sod, plants or mulch.

- 2. Work included. Site finish grading and surface drainage. Installation of any drainage systems detailed on landscape plans. Note: Calch basins shown on landscape plans for coordination only, contras scoped or work price to lad.
 2.2. Detarmine early contrast contrasts of the calculation of the calculation of the calculation of the calculation of all existing utilities and returned are underground utilities pair for commencing over such underground utilities pair for commencing over, such than any one located on of advising and conduct wor so as to prevent interruption of earlies or entire or disnaps to him. Protect existing structures and utility services and be responsible for damage caused.
 3.2. Plantife exists on such Bartle To Section 3.0 In stalling Landscape on Structures.

- Do trenthing and backfilling in accordance with engineering details and specifications.

 Lay drains on prepared bed, true to line and grade with inverts smooth and free of sags or high points. Ensure barrel of each pipe is in contact with bed throughout full.
- . Commence laying pipe at outlet and proceed in upstream direction.

- Commence Javing pipe of mailet and proceed in upstream direction.

 Les perforales place his preforations a big and expo positions.

 Nake joint i light in accordance with manufacturer's directions.

 Donn allow valer from through the place own groundruction except as approved by Engineer.

 Nake valer light connections to earling drains, new or earling manholes or calcibrations where indicated or as directed by Landscape Architect.

 Surround and excern great with drain race in uniform 5 formal layers to arround adoption as shown in defaults, minimum 90mm.

 Cover drain rock with non-vever effect cicht lap all edges and seams minimum 150mm.

- GROWING MEDIUM TESTING
- tive sample of growing mediun proposed for use on this project to an independent laboratory. Provide test results to Landscape Architect prior to
- ubmit representative sample of growing medium proposed for use on this project to an independent p. Test results to include: Physical properties, X content of gravel, sand, sitr, clay and organics. Addity Pland aquantities of line or subhur required to ling within specified range. Nutrient levels of principle and trace elements and recommendations for required soil amendments
- ENT I for the performance of the Contract. Do not load, transport or spread growing medium when it is so wet that its structu
- 2 Supply all growing medium admixtures as required by the soil test. Amended growing medium must meet the specification for growing medium as defined in
- us areas. Thoroughly mix required amendments into the full depth of the growing medium. Special mixes may be required for various situations. Refer to drawing notes for instructions.
- Place the amended growing medium in all grass and planting areas. Spread growing medium in uniform layers not exceeding 6" (150nm), over unfroz standing water.

- 5 Manually spread growing medium/planting soil around existing trees, shrubs and obstacles
- .6 In perimeter seeded grass areas, feather growing medium out to nothing at edges and blend into existing grades
- .7 Finished grades shall conform to the elevations shown on landscape and site plans.

- is ROUGH GRASS AREA SEEDING

 1 General: Rough grass areas are noted on the drawings as "Rough Grass". Treat all areas defined as rough grass between all property lines of the project including all boulerards to edge of roads and lanes. Preparation of Surfaces: To B.C. Landscape Standard Class 3 Areas (Rough grass) Section 7.1.1.3
 Clean existing soil by mechanical means of debris over 50mm in any dinension.
 Ze Roughly grade surfaces to allow for maintenance specified and for positive drainage.
- 5 Seed Mixture: All varieties shall be rated as strong performers in the Pacific Northwest and are subject to client approval.

- 10% Creeping Red Fescue
 20% Arousk Rye
 3% Scalar Personal Rye
 3% Reductor Diseases
 3% Reductor Diseases
 3% Reductor Diseases
 3% Reductor Diseases
 40% Wildfolder Areas use a mixture of Wildflowers with Hard Fescues (Terralink Coastal Wildflowers) with Hard Fescue or pre-approved alternate.
- .6 Fertilizer: Mechanical seeding Apply a complete synthetic slow-release fertilizer with maximum 35% water soluble nitrogen and a formulation ratio of 18-18-18 50% sulphur urea coaled, 112 kg/hal/MMbs/acre using a mechanical spreader.
- .7 Seeding: Apply seed at a rate of 112k/H (100lbs /acre) with a mechanical spreader. Incorporate seed into the top 1/4" (6mm) of soil and lightly com

- y Drused as an alternate to mechanical seeding in rough grass areas. 2 May not be used in areas of lawn unless pre-approved by the Landscape Architect prior to bidding.

- 3 Preparation and Growing Medium:
 3.1 In areas of Rough Grass: Comply with Section 3-6 Bough Grass.
 3.2 Where approved for use in areas of Lawn, comply with Section 3.8 Lawn Areas: Sodding.
- A. Protection: Ensure that fertilizer in solution does not cone in contact DNA_Le foliage of any trees, shrubs, or other susceptible vegetation. Do not spray seed or much on objects not expected to grow grass. Protect existing sile equipment, readvers, incompanies, reference points, monments, markers and structures from diamage. Where contamination occurs, convoice seeding unity to startification of and peness approved by Primateurops Architect.
- 5 Mulch shall consist of virgin wood fibre or recycled paper fibre designed for hydraulic seeding an for wood fibre substitute use 135% (by weight). Conform to B.C. Landscape Standard for mulch require 6. Water: Shall be free of any inpurities that may have an injurious effect on the success of seeding or may be harmful to the
- J. Equipment: Use industry standard hydraulic seeder/mulcher equipment with the tank volume certified by an identification piate or sticker equipment. The hydraudic seeder/mulcher shall be capable of sufficient agriation to mix the analetial into a homogenous sturry and to maintain it is applied. The discharge pumps and pion mazzies shall be capable of applied the nativistation regivery ever the designative eyes the designative verification and produce the standard of the capable of applied the nativistation regiver verifications.

PART THREE SOFT LANDSCAPE DEVELOPMENT - CONT

- .8 Application Rate:
 3.1 Seed Mixture: 136 kg/ha (125 lbs/acre)
 8.2 Fertiker: 178 kg/ha (109 lbs/acre)
 8.3 Coastal Wildflower Mix: Where specified, apply (31 lbs/acre) 11/4 lb: 1 lb. of grass seed)
- A.1. Note:

 A.4.1 At the line of Tender provide a complete chart of all components of the nix proposed including mulch, tackiffer, water etc. Stoped sites 7.8.2.2 Earnillizer

 A.4.2 Familizer

 A.4.1 Rough Grass if a sol analysis is available, comply with results.

 A.4.2 Laun When phytosededinc is seen...
- 9. Accurately measure the quantities of each of the materials to be charged into the tank either by mass or by a commonly accepted system of mass-calibrated volume measurements. The materials shall be added to the tank while it is being falled will water, in the following sequence, seed, fertilizer. Thoroughly ank into a homogenous After charging, adds ovaler or other material to the mature. Do not level subtry in the safe from or the fine of (1) boxes.
- .10 Distribute slurry uniformly over the surface of the area to be hydroseeded. Blend application into previous applications and existing grass areas to form uniform surface
- .11 Clean up: Remove all materials and other debris resulting from seeding operations from the job site.
- 38 Acceptance of the Rough Grass Areas: Proper germination of all specified grass species is the responsibility of the Landscape Contractor. The grass shall be reasonably well established, with no apprend todar or bare sport and shall be reasonably free of veeds the B.C. Landscape Standard, Section 19 Haintenance Level 4 (Open space). Surfy days after substantial completion, areas meeting the conditions above will be taken over by the Owner. Areas seeded in Fall will be accepted in Spring one month after start of growing season, provided that the above continos for acceptance are fulfilled.

- 1 General: Treat all areas defined as lawn areas on the landscape plan between all property lines of the project including all boulevards to edge of roads and lanes
- Growing Medium: Comply with Section 2.2.1, Growing Medium. Prior to sodding, request an inspection of the finished grade, and depth and condition of growing medium by the Landscape Architect.

- .5 Specified Turfgrass by area: Refer to Table 2 below.

Area	Description	Quality Grade	Major Species
CLASS 1	Lawn, all areas noted on drawings as lawn in urban development sites including boulevard grass	No. 1 Premium	Kentucky Blue for sun, Fescues for shade
CLASS 2	Grass - public parks, industrial and institutional sites	No. 2 Standard	same
CLASS 3	Rough Grass	see hydroseeding	
SPECIAL		1	1

- 6 Line: The line shall be as defined in Section 2.2.3 Materials. Apply at rates recommended in required soil test. Refer to Section 3.4 for meth
- 7. Fertilizer: Refer to Section 2.22 Materials. Apply specified fertilizer at rates shown in the required soil test. Apply with a mechanical spreader. Cultivate into growing medium 48 hours prior to sodding. Apply separately from line. 3 Sodding Prepare a annealh, fire, even surface for laying and Lay and staggered with sections closely buffed, without overlapping or gaps, smeath and even with adjining areas and real lightly. Water to obtain moisture penetration of 3" to 4" (T - 19ca). Comply with requirements of BC Landscape Standard Section 8, BC Standard for Turfgress
- 9. Maintenance: Begin maintenance immediately after sodding and continue for 60 days after Substantial Completion and until accepted by the Owner. Protect sodded areas from damage with temporary view or Ivine fences complete with signage until at man is taken over by the Owner. Water to obtain anoisticer penetration of 37 to 4° Th-Tochal at indirects ancessary. To maint is sufficient features, begins a source in the place of begins a transport of the provide adequate protection of sodded areas against damage until the let fas been taken over by Owner. Repair any damaged areas, re-grade as necessary. Aeration may be required if in the Landscape Architect's opinion, drainage through the sod base needbus in Suprace.
- .10 Acceptance of Lawn Areas: The truf's shall be reasonably well established, with no apparent dead spots or bare spots and shall be reasonably free of weeds (to B.C. Landscape Standard, Section 19 Haintenance Level Z Upperanvel. Use herbicides if necessary for weed removal unless other conditions of contract forbid their use. After the Lawn has been cut if least hiving, ears antering the condition show will be taken overly the Owner.

9 PLANTS AND PLANTING

- .1 Conform to planting layout as shown on Landscape Plans.
- .2 Obtain approval of Landscape Architect for layout and preparation of planting prior to commencement of planting operation

- 4. Time of Placing.
 A. The of Placing.
 A. The of Placing.
 A. The of Placing and groundcovers only during periods that are normal for such work as determined by local weather conditions when seasonal conditions are likely tensure successful adaptation of plants to their new location.
- S. Internations
 S. S. All plant and artist shall conform to the requirements of the B.C. Landscape Standard, 7th edition 2008, unless exceeded by drawing Plant Schedule or this specification.
 S.11 Pater to B.C. Landscape Standard, Section S. Plants and Planting and in Section 12, BCLNA Standard for Container Grown Plants for minimum standards.
 S.12 Pater to Plant Schedule for specific plant and container sizes and comply with requirements.
 S.2 Plant material oblained from areas with less server climatic containers shall be grown to withstand the site climate.

- Obtain written approval of the Landscape Architect prior ro making any substitutions to the specified material. Non-approved substitutions will be rejected. Allow a minimum of 5 days prior to delivery for request to substitute. Substitutions are subject to BC Landscape Standard – definition of Conditions of Availability.
- Plant Species & Location
 Plants shall be true to name and of the height, caliper and size of root ball as shown on the landscape/size plan plant schedule. Caliper of trees is to be taken 6" (IScn)
- above grade.
 9.2 Plant all specified species in the location as shown on the landscape drawings. Notify Landscape Architect if conflicting rock or undergr encountered. .9.3 Deviation of given planting location will only be allowed after review of the proposed deviation by the Landscape Architec
- 11 Drainage of Planting folces:
 11. Provide drainage of planting piles where required in on sloped conditions, break out the side of the planting pil to allow drainage down slope; and in flat conditions, mound to raise the restollation winepressor layer. Notify the Landscape Architect where the drainage of planting holes is limited.
- vice.

 222 Eilthe planting holes by gently firming the growing medium around the root system in 6' (Scm) layers. Settle the soil with water. Add soil as required to med grade. Leave no air voids. When 27 off the logosis has been placed, eoply fertilizer as reconnected by the required soil test at the specified rates.

 233 Where planting is incited add spicen to estimating research grade care to avoid disturbance of the root system or natural grades of such trees.

 244 Where frees are in lawn areas, provide a clean cut mulched 90mm (3 H.) dismeter circle centered on the tree.
- Over W. 2. It 3.2 is not, unless, super sector by manupar requestments. 3-es since minimal 1.1 is also. Do not one's super sector in registrostical leaves the friere carefully vertical.

 The with pre-approved commercial, the monipartopoylene fields bell, minimal with 10m [3/4". Approved product: Arbori Ite and addaller from Deep Conference Trees of 81 heights Goy with three 2-strand wires (11 gauge). Drive three stituse equidistral around the free completely below grade.

 Trees 61". on Notion of concrete Decis. Goy as above using three deadness Imm. 7½2"34") burind to the maximum possible depth instead of stakes.

 Mark all goy views this whole flaging analysis.

- 15 Mulching: 15.1 Mulch all planting areas with an even layer of mulch to 2-1/2 3" (65 75mm) depth. Confirm placement of mulch in areas labeled "Groundcover Area" on drawings. Mulch a

- The National Administrators of the State of State of State of State of State of State of Completion of State of
- 3.P Plant Narraety.
 3.P Replace all unsatisfactory goant material except those designated "Specimen" for a period of one (II) year after the Certificate of Completion. Replace all unsatisfactory goant material designated "Specimen" for a period of two (I2) years after the Certificate of Completion. Replace all unsatisfactory trees and shortes and continue to replace these until the specified number is complete and satisfactory to the Landscape Architect. So, berefacement shall be subject to the notification, inspection and approval as specified for the original planting, and shall not constitute an extra to the Contract.
 3.2. Those Plants, destinified as hely without one order of the Contract Applicatives tomal class for the area, specified by the Landscape Architect and installed by the Landscape Contracte which are balled through below normal temperatures believe the verage of the extreme minimum temperatures officially recorded in the area concremed, in the last Vigeral, villate the Argued exilident case of replacements from the Vigeral Applicative for placed exilidated contractives.
 3.3.3. A review any be requested during the latter part of the varranity growing settom. All plant material showing well developed foliage, healthy growth and bud foreings, vill these to Manner over.

PART THREE SOFT LANDSCAPE DEVELOPMENT - CONT

- .18.4 For all plant material, the Landscape Architect reserves the right to extend the Contractor's responsibility for another growing season if, in his opinion, leaf development and grawth and sufficient to except fullow salisfactory grawth.

 The contractor is a contractor of the contract may be declared und.

 The Landscape Architect shall determine whether antenances has been existed and under the CL candscape Stander, Section St, Maintenance as the guide. The required maintenance standard is a minimum of Level Three Medium. Refer to Section 31, Establishment Maintenance.
- 18.0 Description of Completion.

 18.7 Deviation from the specifications may require extension of the Warranty Period as determined by the Landscape Architect.

- Verify that drainage and protection material is completely installed and acceptable before beginning work. Contact Landscape Architect for instructions if not in place.
- Coordinate work with construction of planters and planter drainage.

 1. Verify that planter drains are in place and positive drainage to roof drains is present prior to placing any drain rock or soil.
- .3 Provide clean out at all through-slab drain locations . USE-340mm min. dia. PVC Pipe filled with drain rock unless specific drawing detail shown. Install drain rock evenly to a minimum depth of 4" (100mm)or alternate sheet drain if specified. Install sheet drain as per manufacturer's recomm
- 5. Cover drain rock for alternate sheet drain if specified on drawing details) with filter fabric Lapping 4" (ISSImm) at all edges. Obtain approval of drainage system prior to placing growing medium.
- J. Place growing medium to depths specified in Section 35 above for various surface treatments. Refer to Drawing details for any light weight West required to alter grade. Use Styreforan block over drain rock shaped to provide smooth surface transition at edges. But each piece highly together and cover with filter fabric Department sail from migrating downware.

11 ESTABLISHMENT MAINTENANCE (Provide a senarate price for this section)

- Intent: The intent of "establishment" maintenance is to provide sufficient care to neuty installed plant material for a relatively short period of time to ensure or increase the long term success of the planting. The objective is the adaptation of plants to a new site in order to obtain the desired effect from the planting while reducing the rate of failaire and unnecessary work associated with improper establishment. Establishment of maintenance procedures apply to all new and retained vegetation including cultivated unifgrass areas and new trees and shrubs.
- .2 Maintenance Period: Provide maintenance of installed landscaping for 12 months following substantial completion
- .3 Related Standards and Legislation: B.C. Landscape Standard, Latest edition: Fertilizer Code., B.C. Pesticide Control Act.
- 4. Site Review: In addition to the inspections at substantial completion, at final progress draw application, and at the end of the guarantee period, there should be three othe reviews during the 12 months at Handed by the Contractor and a designated representative of the Owner. Maintain a logbook and reporting procedures and submit to the designated representative.
- 5 Scheduling: Prepare a schedule of anticipated visits and submit to designated representative at start-up. Maintenance operations shall be carried out pred the growing season between March 1st and November 30th, however visits at other times of the year may be required.
- Maintenance Level: Comply with B. C. Landscape Standard, Section 13, Table 7, Maintenance Level "Medium"
- 1 Materials: Comply with Part Two of this specification.
 1.1 Fertilizers: To the requirements of the B.C. Landscape Standard. Formulations and rates as required by soil testing.
- 8. Plant Markrial Establishment.
 3.1 Valeting Divinible first growing season, water new plants at least every ten (10) days between April tat and July 31st, and every hearty (20) days between August 1st and September 51st. Minimum 25 gallous per free per application. During the scene drowing season, water new plants at least every hearty days between April 1 and July 31 and once between August 1st and September 31st. Apply water at an area dorwarion south that the water context reaches field capetity. The foll depth of proving needum. Apply water again when the valer context reaches 23% of field capetity. Provide and ringst with water in the event that any advantal regions system natfunctions or has not been congelerly installed. Schooled applications of valer what bill missed only the mirrialful has pereinted the sol fully a receipted.
 2.8 Mich. Maintain mutches in the original areas and to the original depths.
 3.1 Weed Cortin. To denove all weeds from all areas at least one or per month during the growing season by heeing or cultivation to a maximum depth of 80m, hand-pulling, or, if
- 8.3 Weet Control. Remove all weeds from all areas at least once per month moting the growing season by heeing or cultivation to a maximum deglin of 80m, hand-pulling, or, if necessary, by the use of herbidies.
 8.4 Pest and Disease Control. Inspect all planet areas for pests and diseases periodically and at least every two months during the growing season by an experience.
 8.5 Tere Support: Manifest instance for pests or diseases promptly and consistently for maximum effectiveness. Comply with all BC. Pestidioc Control Act and municipal requirements.
 8.5 Tere Support: Manifest instances, pay vierse and less one full growing season. Disch lies at least every two months to ensure that they are not causing a depression in the best. Lossone, reprint or replace lies as necessary. Remove all stakes by urises and this sort file in first growing season except where large free reservation explores support in the option on the Landscape Architect. All flagging of goy urises shall be visible and in good repair.
 8.6 Prunting, Isspect all three and strivate is least every two months during the growing season prunt to remove all dead, veak or diseased wood. Maintain the natural shape of the plant. Carry out disping or shaping only if required in the mail-tenance contract for specific variaties or conditions.
 3.7 Fertilisage, Overdings the valvee month provided of Ediblishment analmentates retiral stable, these, and consoloures according to soil analysis requirements.

- 9. Grass Areas Establishment:
 3. Watering Use bees and sprinklers, inrigation systems or other methods to apply water to Class 1 and Class 2 grassed areas IB.C. Landscape Standard, Section 7, Lawns and Grasses such that the grass is manitance in a truggle condition. Supply and freque with variet in the event of any irrigation system anaflucction, or incomplete institutions of the event of any irrigation system anaflucction is recomplete institution.
 9.2. Week, insect and Disease Control. Inspect grass areas each time they are moved for eveels, insect parts, and diseases and freat promptly when methods or consider available. See a manual methods, or ly the user of chemicals congularized with the Water Control. Inspect grass areas each time they are moved for eveels, insect parts, and diseases and freat promptly when methods are a manual methods, or ly the user of chemicals congularized with the ESCLA/ the weed population to zero.
 3.5 Perfizings According to sail analysis.
 3.6 Liming According to sail analysis.
 3.6 Liming According to sail analysis.
 4.6 Liming According to sail analysis.
 5.6 Liming According to sail analysis.
 5.6 Liming According to sail analysis.
 5.7 Liming According to sail analysis.
 5.8 Liming According to

39. Me are me remonstrated to the control of the co



LANDSCAPE ARCHITECTUR #220 - 26 Lorne Mews New Westminster, British Columbia

Tel: 604.553.0044 Fax: 604 553 0045 Email: office@m2la.com

ISSUED FOR DE ISSUED FOR DE ISSUED FOR DP ISSUED FOR DE NO DATE REVISION DESCRIPTION DR.

SINGLE FAMILY RT-2D. **OFF-SITE&ON-SITE LANDSCAPE** HOWES STREET & SPRICE STREET,

NEW WESTMINSTER, BC

LANDSCAPE **SPECIFICATIONS**

DATE: 09.10.21 SCALE: DRAWN: QL L10 DESIGN: QL

21026 - 09.zl

CHK'D: MTLM

21-026

DRAWING NUMBER:

M2LA PROJECT NUMBER: