

# Attachment 4 Applicant Submission Materials



SHEET

#### ARCHITECTURAL DRAWING LIST

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PROJECT OWNER



ARCHITECTURAL
Inspired Architecture
#5-1480 Marine Drive, North Vancouver BC, V7P 1T6
Amir Farbehi Project Architect, CRP Phone: O 604-770-2088 C 604-773-1015 Email: amir@inspiredarchitecture.ca

LANDSCAPE PRINCIPAL, SW LANDSCAPE ARCHITECT 919 Melbourne Ave. North Vancouver Colombia, V7R 1N8 Steve Wong, Landscape Architect. Phone: C 778 834-8959

Email: stevewong234@gmail.com



ARBORIST GRIZZLY TREE EXPERTS
1032 & 1036 St. Andrew's Street, New Westminster British Columbia V6K 1R9 Daniel Holliday, ISA certified arborist Phone: O 604-362-3604 Email: dan@grizzlytree.ca

NUMBER	SHEET NAME	REVISION	REVISION DATE
A0001	COVER PAGE	7	2022-09-01
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A0100	SITE PLAN-BUILDING SITING	4	2022-09-01
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A0105	VEHICLE MANEUVERING	4	2022-09-01
A0106	SITE PLAN MATERIAL & FINISHES	4	2022-09-01
A0107	SITE PLAN-FIREFIGHTER PATH OF TRAVEL	1	2022-09-01
A0201	BASEMENT FLOOR PLAN & PATIO LAYOUTS	6	2022-09-01
A0202	LEVEL 1 FLOOR PLAN	5	2022-09-01
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A0205	ROOF PLAN	6	2022-09-01
A0210	ADAPTABLE SUITE LAYOUT	3	2022-09-01
A0221	BASEMENT AREA PLAN	6	2022-09-01
A0222	LEVEL 1 ARE PLAN	6	2022-09-01
A0223	LEVEL 2 AREA PLAN	5	2022-09-01
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A0401	BLDG A-NORTH&SOUTH ELEVATIONS	6	2022-09-01
A0402	BLDG B-NORTH&SOUTH ELEVATIONS	6	2022-09-01
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A0404	BLDG B -EAST&WEST ELEVATIONS	6	2022-09-01
A0405	BLDG A&B&NEIGHBOURS ELEVATIONS OVERLAY	4	2022-09-01
A0501	BUILDING A SECTIONS	6	2022-09-01
A0502	BUILDING B SECTIONS	4	2022-09-01
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A0504	NEIGHBOURHOOD SECTIONS	4	2022-09-01
Grand total: 3	37		

CURRENT

## CITY OF NEW WESTMINISTER **INFINITY TOWNHOMES**

### INCORPORATED ADP COMMENTS MAY 16 2022

1032 AND 1036 ST. ANDREWS STREET, NEW WESTMINSTER, B.C.

#### LEGAL DESCRIPTION;

LOTS 19 &18, NEW WEST DISTRICT, PLAN NWP2620 SUBURBAN BLOCK 7, GROUP 1, OF LOTS 12,13,20 & 21.

#### Zoning Bylaw Analysis

405 Infill Townhouse and Rowhouse Residential District (RT)

Lot area	1,617.81 m²	1,7414 ft²		
Section	Required		Pro	posed
Section	Metric	Imperial	Metric	Imperial
405.4 Density				
Above Basement	0.85 max , 1375.14 m <sup>2</sup>	14,801.9 ft²	0.8498	14798.07 ft²
Basement	0.15 max, 242.67 m <sup>2</sup>	2,612.10 ft²	0.1495	2603.88 ft²
Total	1.0 max, 1,617.81 m <sup>2</sup>	1,7414 ft²	0.9993	17401.95 ft²
405.5 Basement elevation	Basement no part more than 1 meter (3.28 feet) out of the ground		Complies	
405.6 Basement size	Basement not larger than the floor above		Complies	
405.7 Principal building h	eight			
Building A height	10.67 m	35ft	10.01 m	32.84 ft
Building B height	10.67 m	35ft	9.87 m	32.40 ft
Average garde	53.82 m	176.58 ft		
405.8 Detached accessory	buildings			
a) Max 15% site coverage	242.67 m²	2612.08 ft <sup>2</sup>	14.93 m²	160.71 ft²
b)Height	One storey		Complies	
c) Location	Not in front yard		Complies	
d) Height	3.6 m	11.81 ft	2.19 m	7.17 ft
e) Enclosed	2 sides max.		Not enclosed	
f) Dormers	No dormers permitted		Complies	
g) Separation from principal building	1 m	3.28 feet	1.21	3.98 ft
h) Setback from lane	Not required – Belleville Street is not a lane		Not required	
i) Setback from a corner	Site is mid-block – not required		Not required	
j) Setback from Belleville street	1.52 m	5 ft	4.88 m	16 ft
405.9 Parking				
a) resident	12 spaces		12 spaces	
b) visitor	1.2 spaces		1 space	
c) Visitor parking	not required in a non-stratified development		stratified	
d) Location	No parking in front yard		Complies	
e) Access	From lane wider than 3.66 metres (12 feet)		Access from Belleville Street	
f) Access	From lane narrower than 3.66 metres (12 feet)		Access from Belleville Street	
i) Setback from Corner	Site is mid-block – not required		Not required	
405.10 Bicycle Parking				
Short Term bicycle	4 space		4 space	
Long Term bicycle	12 space		12 space	

#### Townhouse and Rowhouse Development Permit Area – Setback and Separation Requirements

Section	Requ	rired	Proposed	
Section	m	ft	m	ft
Front Setback	4.27	14.00	4.46	14.63
Rear Setback	7.62	25.00	7.71	25.30
Side Setback - east	4.27	14.00	4.35	14.27
Side Setback - west	4.27	14.00	4.38	14.37
Separation between buildings	8.53	28.00	8.70	28.54
Maximum Building Length	38.10	125.00	28.04	92.00





PROJECT NO.	18203	REV. DATE	2022-09-01
DRAWING NO.	A00	01	REVISION 7

ACC	ACCESSIBLE	HB	HOSE BIB
ACFL	ACCESS FLOOR	HC	HOLLOW CORE
ACT	ACOUSTICAL CEILING TILE	H/C	HANDICAP
AD	AREA DRAIN	HCW	HOLLOW CORE WOOD
ADJ	ADJACENT	HD	HANGAR DOOR
AFF	ABOVE FINISHED FLOOR	HDR	HEADER
ALUM	ALUMINUM	HDWD	HARDWOOD
ANNP	ANNUNCIATOR PANEL	HDWR	HARDWARE
ANOD	ANODIZED	HM	HOLLOW METAL
APPROX	APPROXIMATE	HO	HONEY-COMB
ARCH	ARCHITECTURAL	HOR	HORIZONTAL
AUTO	AUTOMATIC	HR	HOUR
AVB	AIR VAPOUR BARRIER AIR VAPOUR MOISTURE BARRIER	HSKG HSS	HOUSEKEEPING HOLLOW STEEL SECTION
AVM	AIR VAPOUR MOISTURE BARRIER	HT	HEIGHT
В	BASE	HVAC	HEATING / VENTING / AIR CONDITIONING
BF	BIFOLD DOOR	HVY	HEAVY
BLDG	BUILDING	HW	HOT WATER
ВМ	BEAM		
B/O	BOTTOM OF	ID	INSIDE DIAMETER
BOL	BOLLARD	INFO	INFORMATION
BUR	BUILT UP ROOFING	INSUL	INSULATION
		INT	INTERIOR
CAB	CABINET	IMP	INSULATED METAL PANEL
СВ	CATCH BASIN	ISO	POLYISOCYANURATE
CD	COILING DOOR	2000	
CG	CORNER GUARD	JAN	JANITOR CLOSET
CIP	CAST IN PLACE	DATE	MITCHEN
C/L C/L	CONTROL JOINT	KIT	KITCHEN
CLG	CENTRE LINE CEILING	L	LENGTH
CLR	CLEARANCE	LAV	LAVATORY
CMP	COMPOSITE METAL PANEL	LINO	UNOLEUM
CMU	CONCRETE MASONRY UNIT	LL L	LIVE LOAD
COL	COLUMN	LVR	LOUVER
COM	CUSTOMERS OWN MATERIAL	100001254	100 pt. 163 (1754.75)
CONC	CONCRETE	m	METER
CONST	CONSTRUCTION	MATL	MATERIAL
CONT	CONTINUOUS	MAX	MAXIMUM
CORR	CORRIDOR	MECH	MECHANICAL
CPT	CARPET	MED	MEDIUM
CPT-T	CARPET TILE	MEL	MELAMINE
CS	COUNTER SHUTTER	MEP	MECHANICAL, ELECTRICAL AND PLUMBING
CT	CERAMIC TILE	MEZZ	MEZZANINE
CW	CURTAIN WALL	MF	MINERAL FIBRE
C/W	COMPLETE WITH	MFR	MANUFACTURER
		MH	MANHOLE
DCRON	DURACRON	MIN	MINIMUM
DD	DOUBLE SWING DOOR	MISC	MISCELLANEOUS
DEG	DEGREES	MLDG	MOULDING
DEMO	DEMOLITION	MLWK	MILLWORK
DF DIA	DRINKING FOUNTAIN DIAMETER	mm MP	MILLIMETER METAL PANEL
DIM	DIMENSION	MTD	MOUNTED
DL	DEAD LOAD	MTL	METAL
DN	DOWN		METAL
DNAR	DURANAR	N/A	NOT APPLICABLE
DP	DEPTH	NF	NO FRAME (FRAMELESS)
DR	DOOR	NIC	NOT IN CONTRACT
DW	DISH WASHER	No.	NUMBER
DWG	DRAWING	NTS	NOT TO SCALE
EA	EACH	O/C	ON CENTRE
EJ	EXPANSION JOINT	OD	OUTSIDE DIAMETER
EL	ELEVATION	ОН	OVERHEAD DOOR
ELEC	ELECTRICAL	O/H	OVERHEAD
ELEV	ELEVATOR ELECTRICAL BANKS	OPNG	OPENING
EP EPDM	ELECTRICAL PANEL	OPP OS	OPPOSITE OWNER SUPPLIED
EPX	ETHYLENE PROPYLENEDIENE M-CLASS (ROOFING) EPOXY	OWSJ	OPEN WEB STEEL JOIST
EQ	EQUAL	01/30	OPEN WEB STEELSOIST
ES	EMERGENCY SHOWER	Р	PAINT (colour)
EXIST	EXISTING	PC	POWDER COAT
EXP	EXPOSED	P.CONC	POLISHED CONCRETE
EXP-S	EXPOSED STRUCTURE	PD	PLANTER DRAIN
EXT	EXTERIOR	PERP	PERPENDICULAR
EWS	EYE WASH STATION	PH	PHASE
		PL	PROPERTY LINE
F	FRAME	PLAM	PLASTIC LAMINATE
FAAP	FIRE ALARM ANNUNCIATOR PANEL	PLYWD	PLYWOOD
FAB	FABRIC:	PO	POLYSTYRENE
FC	FLASH COVE	POLY	POLYETHYLENE
FD FDN	FLOOR DRAIN FOUNDATION	POLY-U PREFAB	POLYURETHANE PREFABRICATED
FE	FIRE EXTINGUISHER	PREFAB	PREFINISHED
FFE	FINISH FLOOR ELEVATION	PS	PRESSED STEEL
FF&E	FURNITURE FIX TURES & EQUIPMENT	PSFR	PRESSED STEEL FRAME
FHC	FIRE HOSE CABINET	PT	PRESSURE TREATED
FLR	FLOOR	PTD	PAINTED
F/O	FACE OF		
FOC	FACE OF CONCRETE	QT	QUARRY TILE
FOG	FACE OF GLAZING		
FOS	FACE OF STUD	R	RADIUS
FP	FRAME PROTECTION	R/A	RETURN AIR
FRR	FIRE RESISTANCE RATING	RB	RUBBER BASE
FT	FOOT/FEET	RCP	REFLECTED CEILING BASE
041	014004	RD RD	ROOF DRAIN
G()	GLASS (type)	RE	REVOLVING DOOR
GA	GAUGE	REINF	REINFORCED
GALV	GALVANIZED	REF	REFERENCE
GB	GRABBAR CARRACE RIN	REFR	REFRIGERATOR
GBN GC	GARBAGE BIN GENERAL CONTRACTOR	REQ'D RES	REQUIRED RESILIENT FLOORING
GL	GLASS / GLAZING	REV	REVISION REVISION
GRD	GROUND	RM	ROOM
GWB	GYPSUM WALL BOARD	RO	ROLLING DOOR
GWG	GEORGIAN WIRE GLASS	RR	RAPID ROLL DOOR
GYP	GYPSUM	RSF	RESILIENT SHEET FLOORING
0.000 0.00	HE OFF 4953 (1933)	RUB	RUBBER

#### Infinity Townhouses - Unit Summaries

RAINWATER LEADER

SELF-ADHERED MEMBRANE SOLID CORE SOLID CORE WOOD

SOLID CORE WOOD
SINGLE SWING DOOR
SQUARE FEET
SAFETY FLOOR
STRUCTURAL GLAZING
SHEET
SIAMESE CONNECTION

SIDING DOOR
STEEL METAL CARRIER
SLAB ON GRADE
STAND PIPE
SPECIFICATION
SQUARE
STAINLESS STEEL

SOLID SURFACING MATERIAL STONE SOUND TRANSMISSION CLASS

TOP OF STEEL
THERMOPLASTIC POLYOLEFIN TRANSITION STRIP
TEMPERED SAFETY GLASS
TYPICAL

UNDER GROUND UNLESS NOTED OTHERWISE UNDERSIDE

VAPOUR BARRIER
VINYL COMPOSITE TILE VERTICAL VESTIBULE VERIFY IN FIELD

WIDTH WALL COVERING

WATER CLOSET WOOD WATER HEATER WATERPROOF WALL PROTECTION WASHROOM WOOD VENEER

EXTRA HEAVY

SIMILAR SLIDING DOOR

STANDARD STEEL STORAGE STRUCTURAL SUSPENDED

TO BE DETERMINED TRENCH DRAIN TELEPHONE TEMPORARY

TERRAZZO TOP OF TOP OF CURB TOP OF FLOOR

RWL

S/A
SAM
SAM
SC
SC
SCW
SD
SF
SF
SFL
SIG
SHT
SIA
SL
SMC
SOG
SP
SPEC
SQ
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STOR
STOR
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SUSP

TBD
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T/O
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TS
TSG
TYP

U/G UNO U/S

V VB VCT VERT VEST VIF

W/C WD WH WP WPR WPR WRM WV

X-HVY

Unit	Total Floor / the Bas		Basement Fl	oor Area	Balcony	Area	Semi Public Fr Patio A		Private Rear \	ard Area
	m²	ft²	m²	ft²	m²	ft²	m²	ft²	m²	ft²
A01	121.713	1,310.11	29.877	321.59	21.683	233.39	16.519	177.81	19.252	207.23
A02	121.726	1,310.25	29.877	321.59	21.749	234.10	16.033	172.58	19.568	210.63
A03	121.726	1,310.25	29.877	321.59	21.749	234.10	16.222	174.61	19.624	211.23
A04	121.627	1,309.18	31.323	337.16	18.418	198.25	16.101	173.31	19.633	211.33
A05	98.912	1,064.68	0	0.00	0	0.00	20.236	217.82	32.560	350.47
A06	101.689	1,094.57	0	0.00	0	0.00	18.379	197.83	0.000	0.00
B01	121.713	1,310.11	29.877	321.59	21.683	233.39	16.239	174.80	31.406	338.05
B02	121.726	1,310.25	29.877	321.59	21.749	234.10	16.120	173.51	19.568	210.63
В03	121.726	1,310.25	29.877	321.59	21.749	234.10	16.325	175.72	19.624	211.23
B04	121.627	1,309.18	31.323	337.16	18.418	198.25	16.102	173.32	19.633	211.33
B05	98.912	1,064.68	0	0.00	0	0.00	19.595	210.92	32.560	350.47
B06	101.689	1,094.57	0	0.00	0	0.00	17.649	189.97	0.000	0.00
TOTAL	1,374.786	14,798.07	241.908	2,603.88	167.198	1,799.70	205.520	2,212.20	233.428	2,512.60

#### Infinity Townhouses - Site summary

Category	Area m²	Area ft²	Percent site Coverage
Site Coverage	617.78	6,649.73	38.19%
Common Open Space	195.52	2,104.54	12.09%
Project Shared Gardens & Amenity	149.90	1,613.48	9.27%
Site Services	26.11	280.99	1.61%
Parking	189.57	2,040.47	11.72%
Private Rear Yard Area	205.52	2,212.20	12.70%
Semi Public Front Door Patio Area	233.43	2,512.60	14.43%
Total	1617.81	17,414.00	100.00%

		BLDG AVERAGE GRADE CALCULATION							
BLDG A-AVERAGE GRADE CALCULATION		5 M							
Ex. GRADE LEVEL -BLDG NORTH EAST	54.56	m	179	ft					
Ex. GRADE LEVEL-BLDG NORTH WEST	53.86	m	176.72	ft					
Ex. GRADE LEVEL-BLDG SOUTH EAST	52.30	m	171.59	ft					
Ex. GRADE LEVEL-BLDG SOUTH WEST	52.17	m	171.15	ft					
AVERAGE EXISTING GRADE	53.22	m	174.62	ft	7				
BLDG A ROOF RIDGE	63.23	m	207.46	ft					
BLDG A HEIGHT	10.01	m	32.85	ft	V 4				
BLDG B-AVERAGE GRADE CALCULATION		_							
Ex. GRADE LEVEL -BLDG NORTH EAST	55.66	m	182.6	ft					
Ex. GRADE LEVEL-BLDG NORTH WEST	55.70	m	182.74	ft					
Ex. GRADE LEVEL-BLDG SOUTH EAST	53.59	m	175.83	ft	7				
Ex. GRADE LEVEL-BLDG SOUTH WEST	52.76	m	173.1	ft					
AVERAGE EXISTING GRADE	54.43	m	178.56	ft	8				
BLDG B ROOF RIDGE	64.30	m	210.96	ft					
BLDG B HEIGHT	9.88	m	32.40	ft	(				



5-1430 MARINE DRIVE, NORTH VANCO UVER BRITISH CLOUMBIA V7P 1T6 CANADA EMAIL: INFO @INS PIREDARCHITECTURE CA TEL:604-770-2088

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6	2022-09-01	INCORPORATED ADP COMMENTS	AF
5	2022-05-16	ISSUED FOR NEW WESTMINISTER DESIGN PANEL	AF
4	2022-02-14	REISSUED FOR SECOND HEARING	AF
3	2021-04-14	REISSUED FOR FIRST HEARING	AF
2	2020-02-24	REISSUED FOR FIRST HEARING	AF
1	2019-07-17	ISSUED FOR FIRST HEARING	AF
REV.	YYYY-MM-DD	REVISION / DRAWING ISSUE	REVIEW
CON	SULTANT		

PROJECT

INFINITY TOWNHOMES

1032 AND 1036 ST. ANDREWS STREET, NEW WESTMINSTER, B.C.

DRAWING TITLE

**ABBREVIATIONS** 

INCORPORATED ADP COMMENTS

PROJECT NO.	PLOT DATE	MAY 16 2022	DRAWN	M
18203	SCALE		REVIEWED	100

A0002

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5-1430 MARINE DRIVE, NORTH VANCOUVER BRITISH CLOUMBIA V7P 116 CANADA EMAIL: INFO@NSPIREDARCHITECTURE.CA TEL:604-770-2088

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5	2022-05-01	ISSUED FOR NEW WESTMINISTER DESIGN	AF
3	2022-03-10	PANEL	AF.
4.	2022-02-14	REISSUED FOR SECOND HEARING	AF
3	2021-04-14	REISSUED FOR FIRST HEARING	AF
2	2020-02-24	REISSUED FOR FIRST HEARING	AF
1	2019-07-17	ISSUED FOR FIRST HEARING	AF
REV	YYYY-MM-DD	REVISION / DRAWING ISSUE	REVIEW

PROJECT

#### INFINITY TOWNHOMES

1032 AND 1036 ST. ANDREWS STREET, NEW WESTMINSTER, B.C.

DRAWING

3D VIEWS


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# INCORPORATED ADP COMMENTS

PROJECT NO.	PLOT DATE	MAY 16 2022	DRAWN	MG
18203	SCALE		REVIEWED	AF
DRAWING NO.				REVISION

A0003

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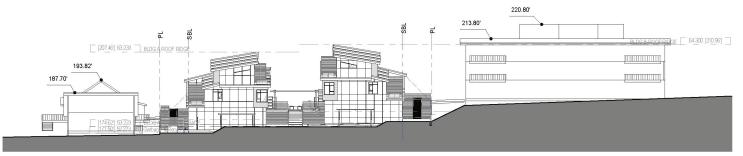
Streetscape-St. Andrews (north)
SCALE: 3/64" = 1'-0"

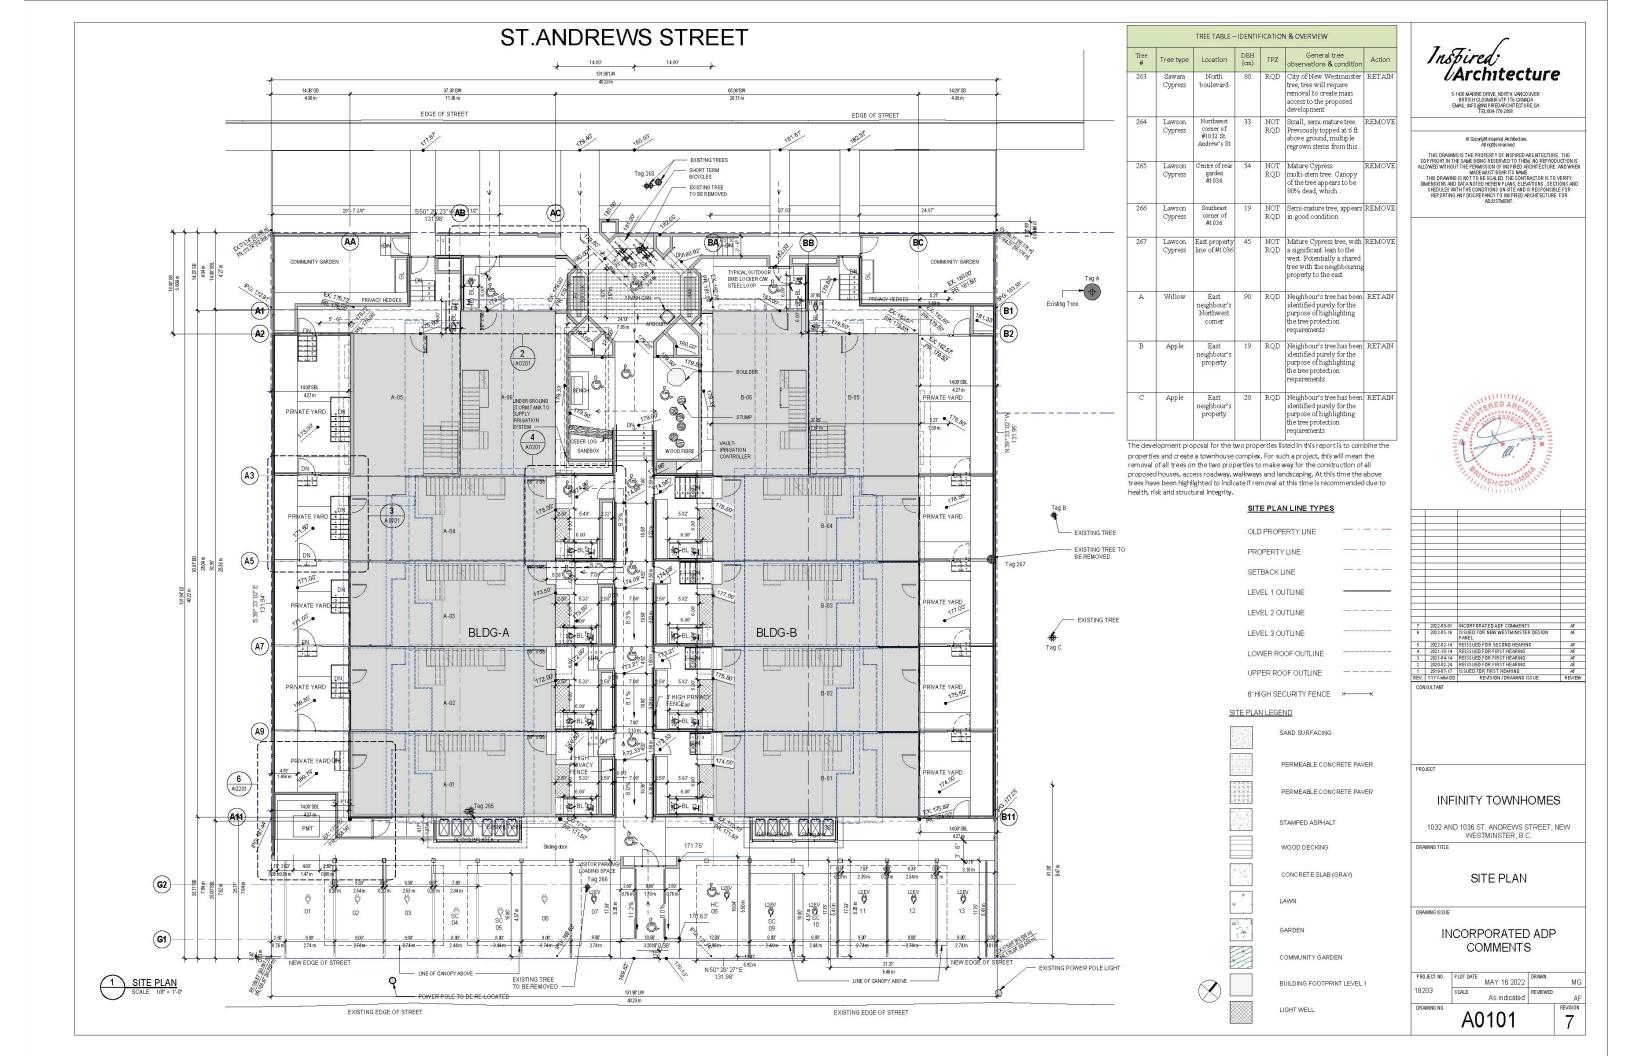

ST. ANDRWES STREETSCAPE VIEW-NORTH-PROPOSED



BELLEVILLE STREETSCAPE VIEW-SOUTH-PROPOSED



4 Streetscape-Belleville Street (south)

SCALE: 3/64° = 1'-0"



5-1430 MARINE DRIVE, NORTH VANCOUVER BRITISH CLOUMBIA V7P 116 CANADA EMAIL: INFO@INSPIREDARCHITECTURE, CA TEL: 604-770-2088

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3	2022-09-01	INCORPORATED ADP COMMENTS	AF
2	2022-05-16	ISSUED FOR NEW WESTMINISTER DESIGN PANEL	AF
1	2021-04-14	REISSUED FOR FIRST HEARING	AF
REV.	YYYY-MM-DD	REVISION / DRAWING ISSUE	REVIEW

CON

PROJECT

INFINITY TOWNHOMES

1032 AND 1036 ST. ANDREWS STREET, NEW WESTMINSTER, B.C.

DRAWING TITL

PROPOSED STREETSCAPE VIEW

DRAWING I

INCORPORATED ADP COMMENTS

PROJECT NO.	PLOT DATE	MAY 16 2022	DRAWN	Author
18203	SCALE	As indicated	REVIEWED	Checker
DRAWING NO.				REVISION

A0103

3